
# SOUTHEAST REGIONAL CRISIS CENTER

Rochester, Minnesota

WSB Project No. ......Issue Date.....

015264-000 - CONSTRUCTION DOCUMENTS FEBRUARY 19, 2020 - ISSUED FOR SECOND CITY REVIEW

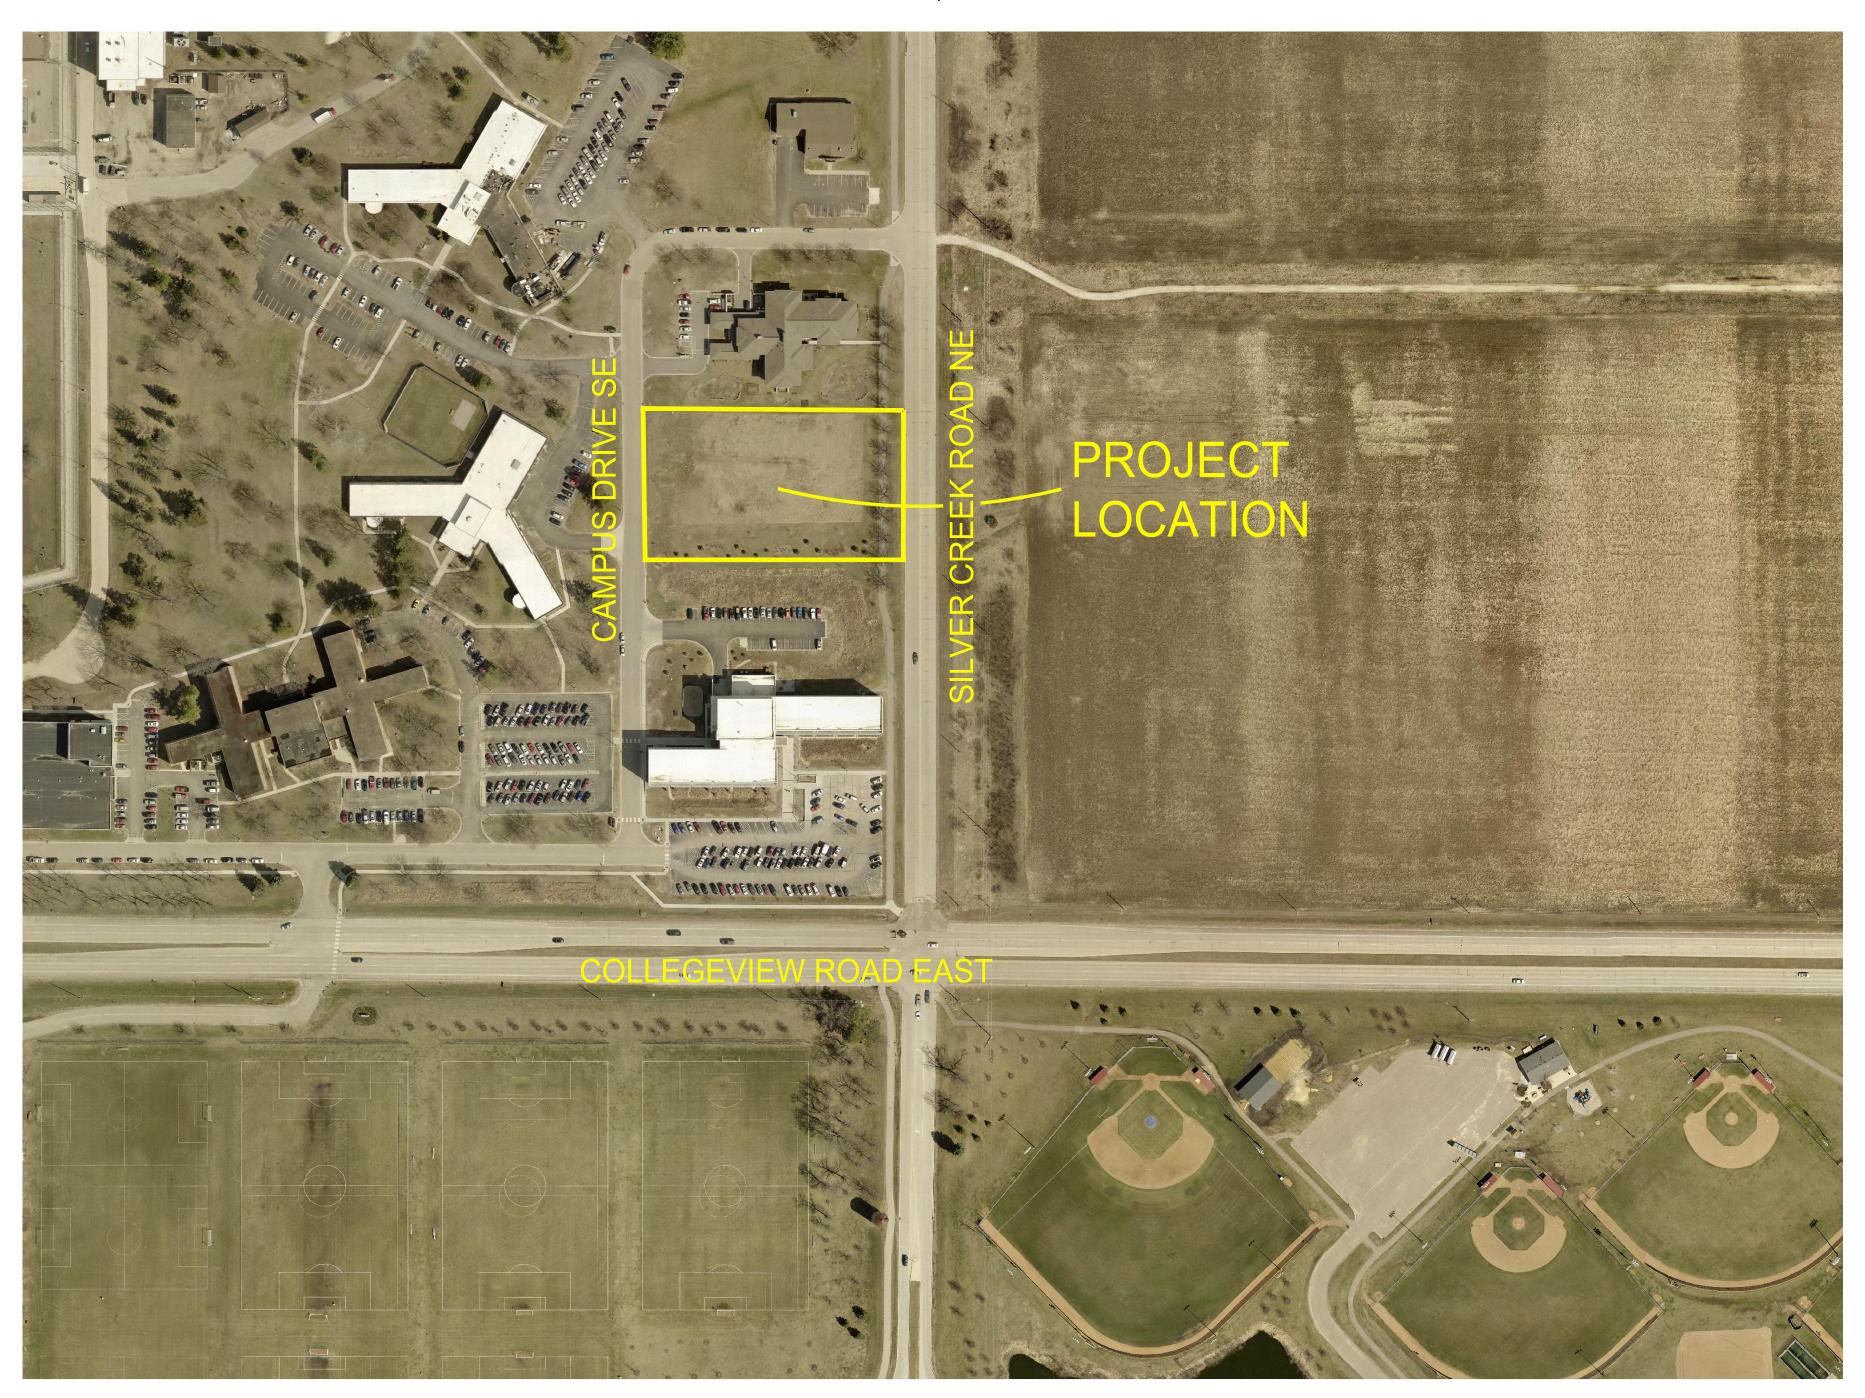


PROJECT LOCATION MAP

CJ100 SCALE: NOT TO SCALE

THE SUBSURFACE UTILITY INFORMATION SHOWN ON THESE DRAWINGS CONCERNING TYPE AND LOCATION OF PRIVATE UTILITIES HAS BEEN DESIGNATED UTILITY QUALITY LEVEL D. THESE QUALITY LEVELS WERE DETERMINED ACCORDING TO THE GUIDELINES OF CI/ASCE 38-02, ENTITLED "STANDARD GUIDELINES FOR THE COLLECTION AND DEPICTION OF EXISTING SUBSURFACE DATA". THE CONTRACTOR IS TO DETERMINE THE TYPE AND LOCATION OF PRIVATE UTILITIES AS MAY BE DEEMED NECESSARY TO AVOID DAMAGE THERETO.

### LEGAL DESCRIPTION:

THAT PART OF THE SOUTHEAST QUARTER OF THE SOUTHWEST QUARTER OF SECTION 31, TOWNSHIP 107 NORTH, RANGE 13 WEST, OLMSTED COUNTY, MINNESOTA, CONTAINING 81,825 SQ. FT. MORE OR LESS.

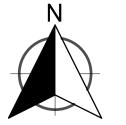

	Sheet List Table
Sheet Number	Sheet Title
CJ <mark>100</mark>	COVER SHEET
CD100	<b>EXISTING CONDITIONS &amp; REMOVALS PLAN</b>
SDP100	SITE DEVELOPMENT PLAN
CS100	CIVIL SITE PLAN
CS500	SITE DETAILS
CS501	SITE DETAILS
CG100	GRADING & DRAINAGE PLAN
CG101	SOUTHWEST GRADE DETAIL
CG102	NORTHWEST GRADE DETAIL
CG110	SEDIMENT & EROSION CONTROL PLAN
CG111	STORMWATER POLLUTION PREVENTION PLAN
CG112	SEDIMENT & EROSION CONTROL DETAILS
CU100	UTILITY PLAN
CU500	UTILITY DETAILS
LS100	LANDSCAPE PLAN
LS101	LANDSCAPE PLAN ENLARGEMENT
LS500	LANDSCAPE SCHEDULE
LS501	LANDSCAPE DETAILS & NOTES

### **CITY OF ROCHESTER**

Project J-5532 SOUTHEAST REGIONAL CRISIS CENTER (SERCC)

Approved By	RPU - Water Division	Date
Approved By	City Engineer	Date

### **GENERAL NOTES:**

- 1. EXISTING SITE INFORMATION WAS TAKEN FROM A BOUNDARY AND TOPOGRAPHIC SURVEY COMPLETED BY WSB, ROCHESTER MINNESOTA DATED JULY 16, 2019. ACTUAL FIELD CONDITIONS MAY VARY. VERIFY ALL FIELD CONDITIONS INCLUDING LOCATION OF UNDERGROUND UTILITIES PRIOR TO CONSTRUCTION. NOTIFY THE OWNER AND ARCHITECT OF ANY DISCREPANCIES AFFECTING THE SCOPE OF THIS CONTRACT. SEE SURVEY FOR BENCHMARK INFORMATION. PROTECT ALL PROPERTY CORNERS. RELOCATE BENCHMARKS AS NECESSARY WITH NEW BENCHMARK LOCATIONS WITHIN A TOLERANCE OF 0.010 VERTICAL FEET.
- 3. THE PROPOSED GRADES SHOWN ON THE GRADING PLAN ARE FINISHED GRADE.
- 4. GRADING ACTIVITY WHICH BLOCKS TRAFFIC OF ANY STREET, ALLEY, OR DRIVE IS SUBJECT TO APPROVAL BY THE CITY AND COUNTY.
- 5. CONTRACTOR SHALL STOP WORK IMMEDIATELY AND NOTIFY THE ENGINEER AND OWNER IF CONTAMINANTS ARE FOUND IN THE EXISTING SOILS.
- SIDEWALK CROSS-SLOPES SHALL NOT EXCEED 2.0% AND LONGITUDINAL SLOPES SHALL NOT EXCEED 5.0% UNLESS OTHERWISE NOTED.
- 7. IN AREAS WHERE NEW FILL IS TO BE PLACED ON SLOPING GROUND, BENCHING THE SURFACE SHALL BE COMPLETED PRIOR TO PLACING THE FILL. BENCHING SHALL BE COMPLETED WHERE SLOPES ARE STEEPER THAN 4:1 (HORIZONTAL:VERTICAL).
- 8. PROVIDE POSITIVE DRAINAGE AT ALL TIMES WITHIN THE CONSTRUCTION AREA. DO NOT ALLOW WATER TO POND IN EXCAVATION AREAS, AND MAINTAIN ALL EXISTING DRAINAGE PATTERNS.
- 9. UNLESS OTHERWISE NOTED, FINISH GRADE SHALL BE SIX INCHES BELOW FINISHED FLOOR IN NON-PAVED
- 10. THE CONTRACTOR SHALL BE RESPONSIBLE TO COMPLY WITH ALL OSHA REGULATIONS IN THE EXECUTION OF WORK UNDER THIS CONTRACT
- 11. THE CONTRACTOR SHALL APPLY FOR A CITY OF ROCHESTER GRADING PERMIT BEFORE STARTING WORK. THE INSPECTOR AND THE CITY OF ROCHESTER PUBLIC WORKS DEPARTMENT SHALL BE NOTIFIED BY THE CONTRACTOR 48 HOURS BEFORE START OF CONSTRUCTION. NO WORK MAY BEGIN UNTIL THE PERMIT HAS BEEN RECEIVED AND THE CONTRACTOR MUST COMPLY WITH THE TERMS OF THE PERMIT.
- 12. ALL NON-PAVED AREAS SHALL RECEIVE A FOUR-INCH (4") LAYER OF TOPSOIL. SEE EROSION AND SEDIMENT CONTROL PLANS & SPECIFICATIONS FOR TEMPORARY STABILIZATION REQUIREMENTS AND LANDSCAPE PLANS FOR PERMANENT GROUND COVER.
- 13. ALL GRADES WITHIN THE LANDSCAPED AREA SHALL NOT EXCEED 3 HORIZONTAL TO 1 VERTICAL AND HAVE A MINIMUM GRADE OF 2%, UNLESS OTHERWISE NOTED. GRADED SWALES MUST HAVE A MINIMUM BOTTOM SLOPE OF 2.0%. SLOPES STEEPER THAN 4:1 ARE STABLE FROM LAND SLIDING AND SURFACE EROSION.
- 14. ALL EXTERIOR BUILDING WALLS AND FOUNDATION ADJACENT NON PAVED AREAS SHALL BE WATERPROOFED TO AN ELEVATION 0.5' ABOVE EXTERIOR PERVIOUS FINISH GRADE IN ACCORDANCE WITH ARCHITECTURAL PLANS AND SPECIFICATIONS.
- 15. ALL CONCRETE WASHOUT PRACTICES MUST MEET OR EXCEED THE MPCA STANDARDS.
- 16. ALL DISCHARGE OF TURBID OR SEDIMENT-LADEN WATERS RELATED TO DEWATERING OR BASIN DRAINING (E.G. PUMPED DISCHARGES, TRENCH/DITCH CUTS FOR DRAINAGE) SHALL DISCHARGE INTO A TEMPORARY OR PERMANENT SEDIMENT BASIN UNLESS INFEASIBLE. IF A SEDIMENT BASIN IS NOT AVAILABLE, THE CONTRACTOR SHALL TREAT ALL DISCHARGE WITH APPROPRIATE BMP'S SO THAT ANY DISCHARGE DOES NOT ADVERSELY AFFECT THE SURFACE WATER OR DOWNSTREAM PROPERTIES.
- 16. REFER TO "GEOTECHNICAL REPORT FOR: OLMSTED COUNTY CRISIS CENTER", PREPARED BY WSB, DATED JUNE 19, 2019 FOR SUBSURFACE DATA, RECOMMENDATIONS AND BORING LOGS.



701 Washington Ave. N, Ste 200 | Minneapolis, MN 55401 | 612.33



#### WSE

3701 40th Ave. NW Suite 100 Rochester, MN 55901 Tel: 507.218.3369

CLIENT:


**OLMSTED COUNTY OFFICES** 

151 SE 4th Street Rochester, mn 55904

2	02-19-20	SECOND CITY REVIEW
1	01-24-20	50% CD PRICING SET
1	01-24-20	INITIAL CITY REVIEW
NO	DATE	ISSUED FOR

THIS SQUARE APPEARS 1/2"x1/2"

I HEREBY CERTIFY THAT THIS PLAN, SPECIFICATION, OR REPORT WAS PREPARED BY ME OR UNDER MY DIRECT SUPERVISION AND THAT I AM A DULY LICENSED PROFESSIONAL ENGINEER UNDER THE LAWS OF THE STATE OF MINNESOTA.

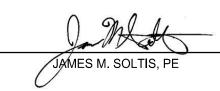

DATE: 02-19-2020 LIC. NO: 54823
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PROJECT NAME:

Southeast Regional Crisis Center (SERCC)


2121 Campus Drive SE Rochester, MN 55904

DRAWING TITLE:

**COVER SHEET** 

DESIGN BY:	JMS	
DRAWN BY:	PJM	
CHECKED BY:	JMT	
PROJ. NO:	015264-000	

CJ100

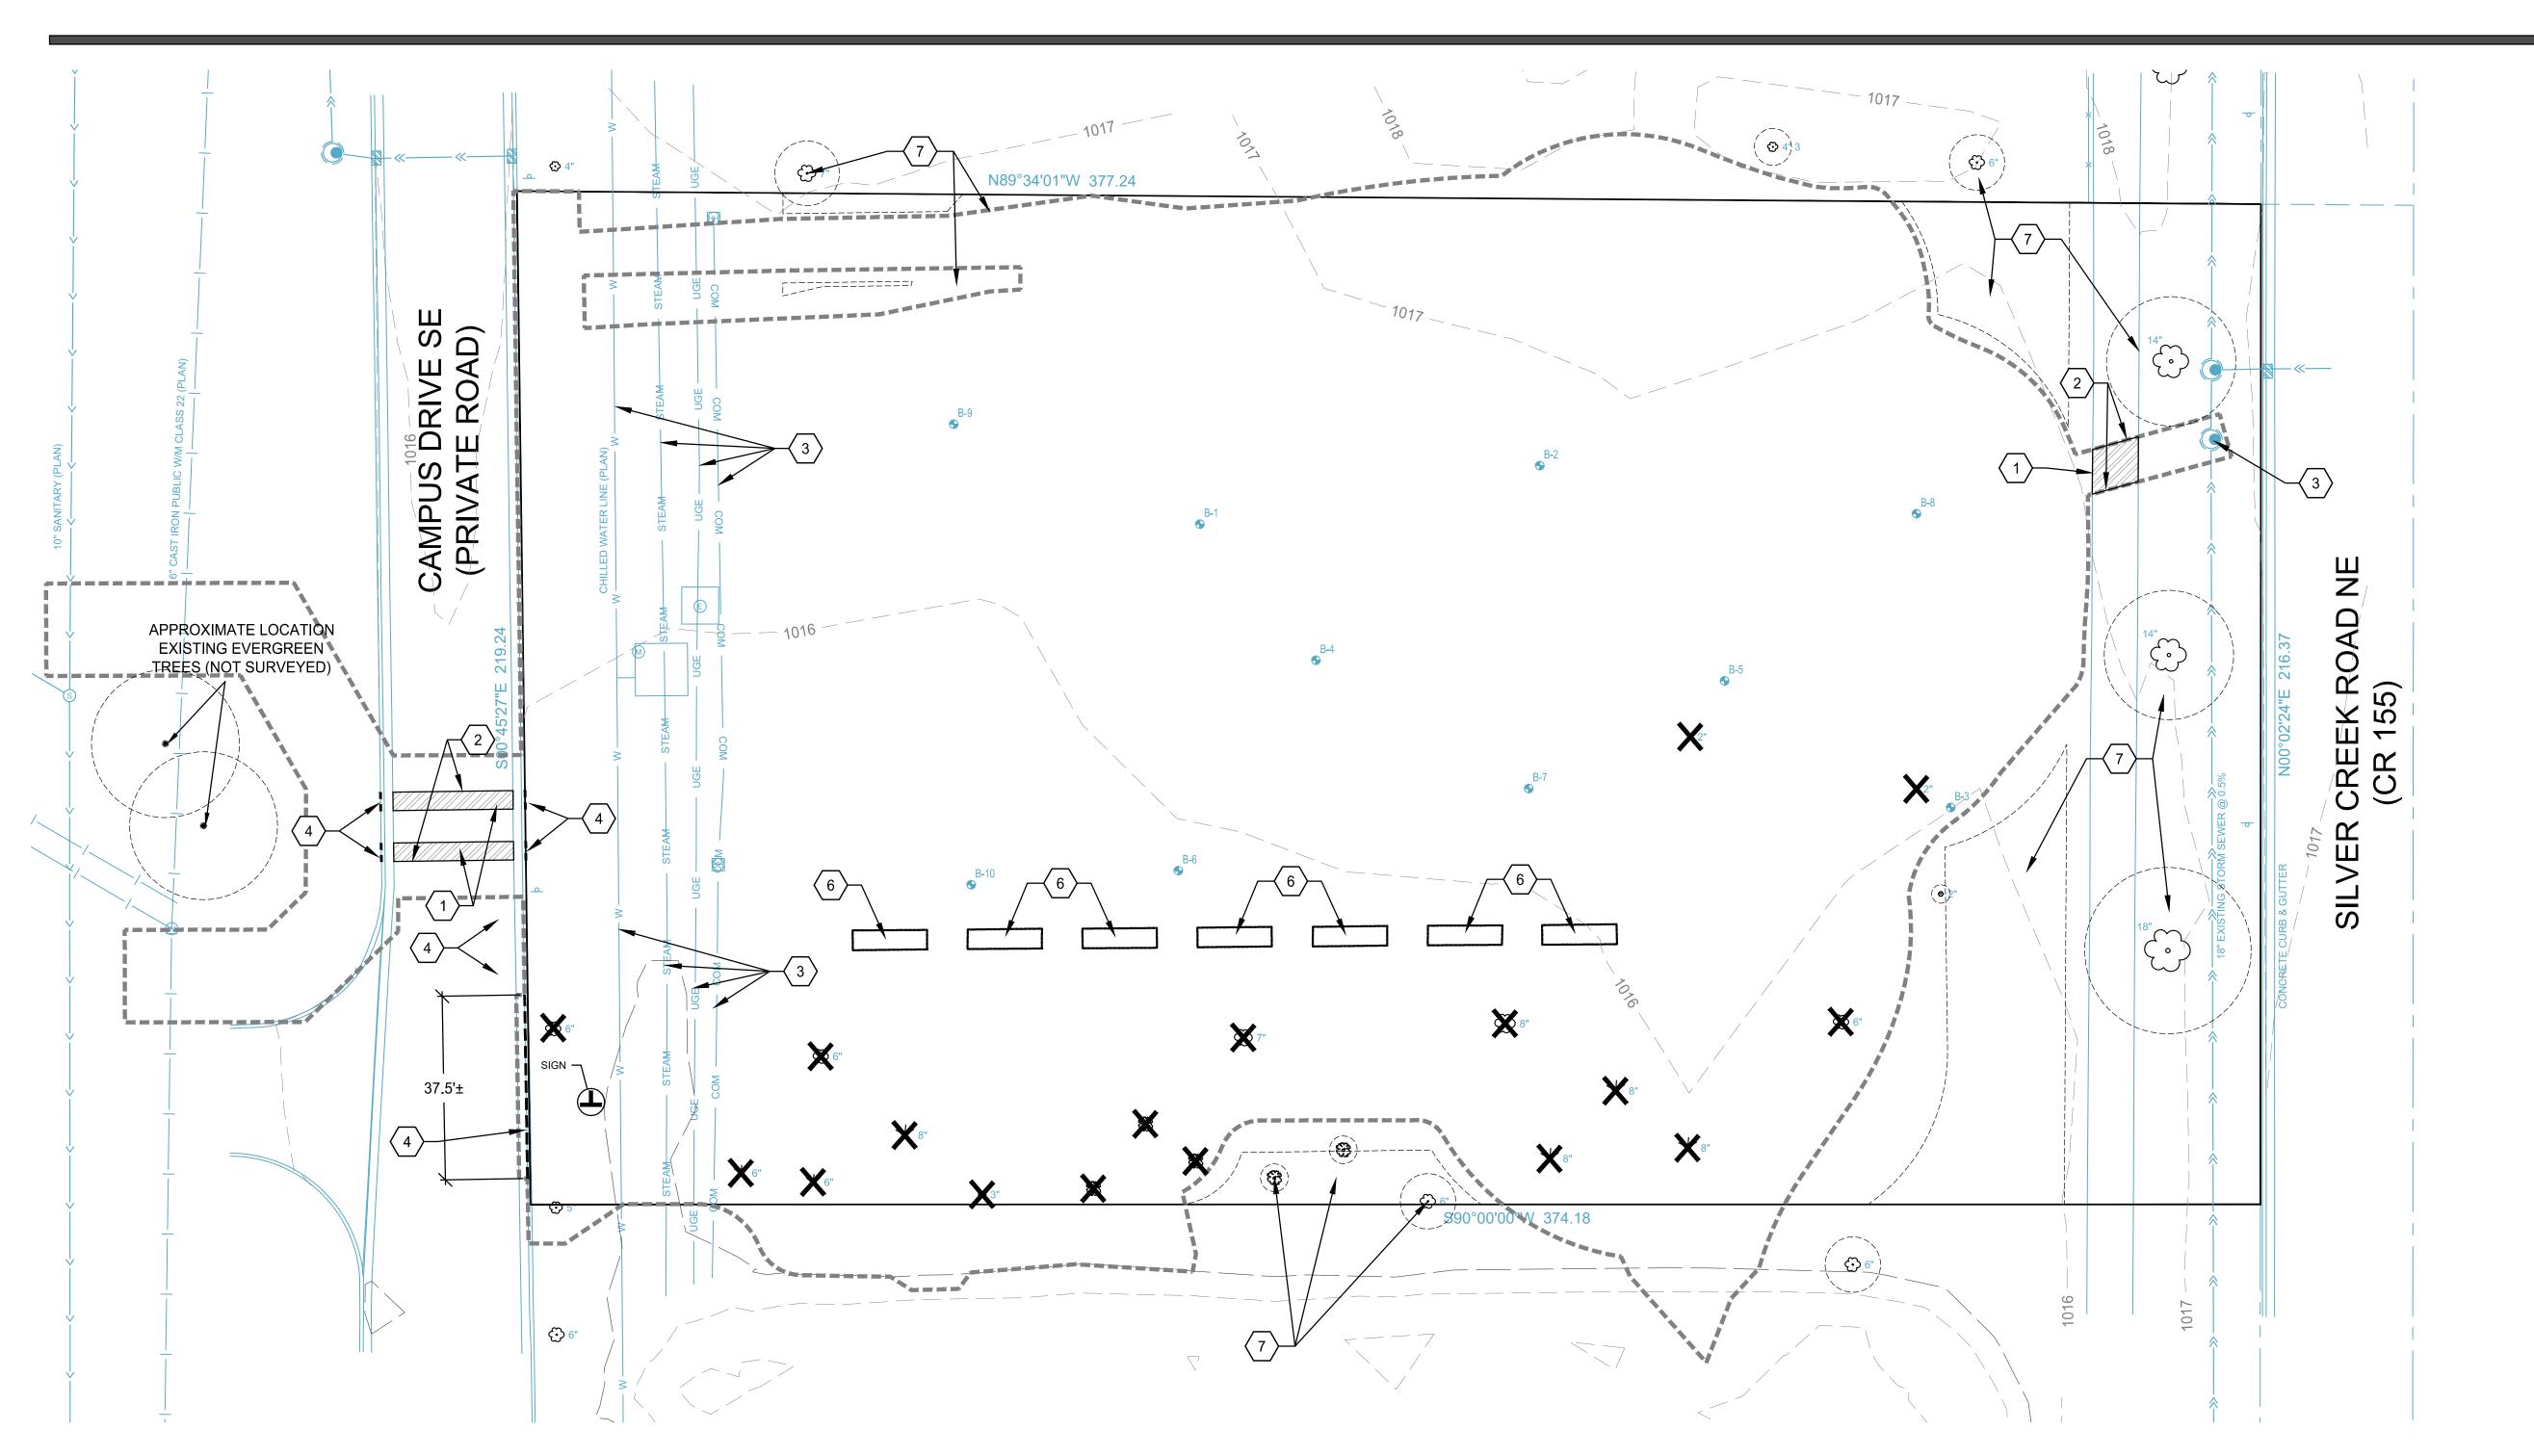

### **DEMOLITION LEGEND:**

---- REMOVE CONCRETE CURB & GUTTER GRADING/DISTURBANCE LIMITS



REMOVE BITUMINOUS PAVEMENT



REMOVE TREE (BY OTHERS)



REMOVE & SALVAGE SIGN



NATIVE SOIL/TREE PROTECTION BOUNDARY

AND IDENTIFICATION

SOIL BORING LOCATION


## **DEMOLITION NOTES**


- SEE SHEET CG110 FOR THE SEDIMENTATION AND EROSION CONTROL PLAN. INSTALL EROSION AND SEDIMENTATION CONTROL PRIOR TO
- 2. MAINTAIN FIRE ACCESS WITHIN 150 FEET OF EXTERIOR AREAS OF ALL BUILDINGS DURING CONSTRUCTION.
- 3. REMOVE TOPSOIL WITHIN LIMITS OF CONSTRUCTION. STOCKPILE ON-SITE FOR USE IN AREAS NOT SCHEDULED FOR BUILDING, PAVEMENT,
- 4. A DIAMOND EDGE SAWBLADE SHALL BE USED FOR CUTTING ALL PAVEMENT MARKED FOR REMOVAL.
- 5. SAWCUT EXISTING PAVEMENT WHICH ABUTS ALL NEW PAVEMENTS TO PROVIDE A STRAIGHT VERTICAL EDGE.
- 6. PROTECT BY WHATEVER MEANS REQUIRED ALL FENCES, SIGNS, STRUCTURES, DRIVES, SIDEWALKS, STREETS, BUSHES, TREES, ETC. WHICH ARE NOT DESIGNATED FOR REMOVAL, OR OUTSIDE THE LIMITS OF
- 7. CONTRACTOR IS RESPONSIBLE FOR REPAIRING ALL DAMAGE INCURRED DURING CONSTRUCTION. THIS INCLUDES, BUT IS NOT LIMITED TO, DAMAGE CAUSED BY SUBCONTRACTORS TO THE GENERAL CONTRACTOR. REPAIRS SHALL EQUAL OR EXCEED THE QUALITY OF **EXISTING CONDITIONS.**

- 8. CONTRACTOR SHALL REMOVE AND/OR RELOCATE ALL ITEMS NECESSARY TO ACCOMMODATE THE PROPOSED IMPROVEMENTS WHETHER SPECIFICALLY CALLED OUT BY NOTE OR NOT.
- 9. THE LOCATIONS OF ALL AERIAL AND UNDERGROUND UTILITY FACILITIES ARE APPROXIMATE OR MAY NOT BE INDICATED IN THESE PLANS. UNDERGROUND FACILITIES, WHETHER INDICATED OR NOT, SHALL BE LOCATED PRIOR TO CONSTRUCTION. IT SHALL BE THE RESPONSIBILITY OF THE CONTRACTOR TO PROTECT ALL EXISTING UTILITIES, PAVEMENT AND OTHER IMPROVEMENTS. ANY DAMAGE TO EXISTING UTILITIES AND/OR PAVED STREETS CAUSED BY CONSTRUCTION OPERATIONS SHALL BE REPAIRED OR REPLACED AT THE CONTRACTOR'S EXPENSE, IN ACCORDANCE WITH CITY OF ROCHESTER PUBLIC WORKS DEPARTMENT STANDARD SPECIFICATIONS FOR CONSTRUCTION, LATEST EDITION.
- 10. ALL DEBRIS AND REFUSE RESULTING FROM CONSTRUCTION OPERATIONS SHALL BE HAULED OFF-SITE AND DISPOSED OF PROPERLY AT THE CONTRACTOR'S EXPENSE.
- 11. EXISTING CONDITIONS SHOWN HEREON PER "BOUNDARY AND TOPOGRAPHIC SURVEY FOR OLMSTED COUNTY CRISIS CENTER" PREPARED BY WSB & ASSOCIATES, INC.
- CONTOUR INTERVAL IS 1 FOOT.

### **KEYNOTES**

- (1) ASPHALT PAVEMENT REMOVAL AND PATCH.
- 2 PAVEMENT SAW CUT LINE.
- (3) PROTECT EXISTING UNDERGROUND UTILITIES.
- (4) CONCRETE CURB AND GUTTER REMOVAL.
- (5) NOT USED
- 6 REMOVE EXISTING PLANTER (BY OTHERS)
- $\langle 7 \rangle$  SOIL/TREE PROTECTION ZONE

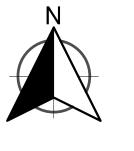

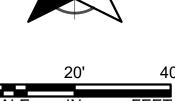

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**PERFORMANCE** DRIVEN DESIGN.




3701 40th Ave. NW Suite 100 Rochester, MN 55901 Tel: 507.218.3369

OLMSTED COUNTY OFFICES

151 SE 4th Street Rochester, mn 55904

THIS SQUARE APPEARS 1/2"x1/2" ON FULL SIZE SHEETS 02-19-20 SECOND CITY REVIEW 50% CD PRICING SET INITIAL CITY REVIEW ISSUED FOR

I HEREBY CERTIFY THAT THIS PLAN, SPECIFICATION, OR REPORT WAS PREPARED BY ME OR UNDER MY DIRECT SUPERVISION AND THAT I AM A DULY LICENSED PROFESSIONAL ENGINEER UNDER THE

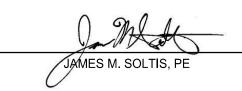

LAWS OF THE STATE OF MINNESOTA.

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PROJECT NAME:


Southeast Regional Crisis Center (SERCC)

2121 Campus Drive SE Rochester, MN 55904

DRAWING TITLE: **EXISTING CONDITIONS &** REMOVALS PLAN

DESIGN BY: JMS DRAWN BY: CHECKED BY PROJ. NO: SCALE:

12. TOPOGRAPHY SHOWN HEREON PER GROUND RUN SURVEY METHODS.

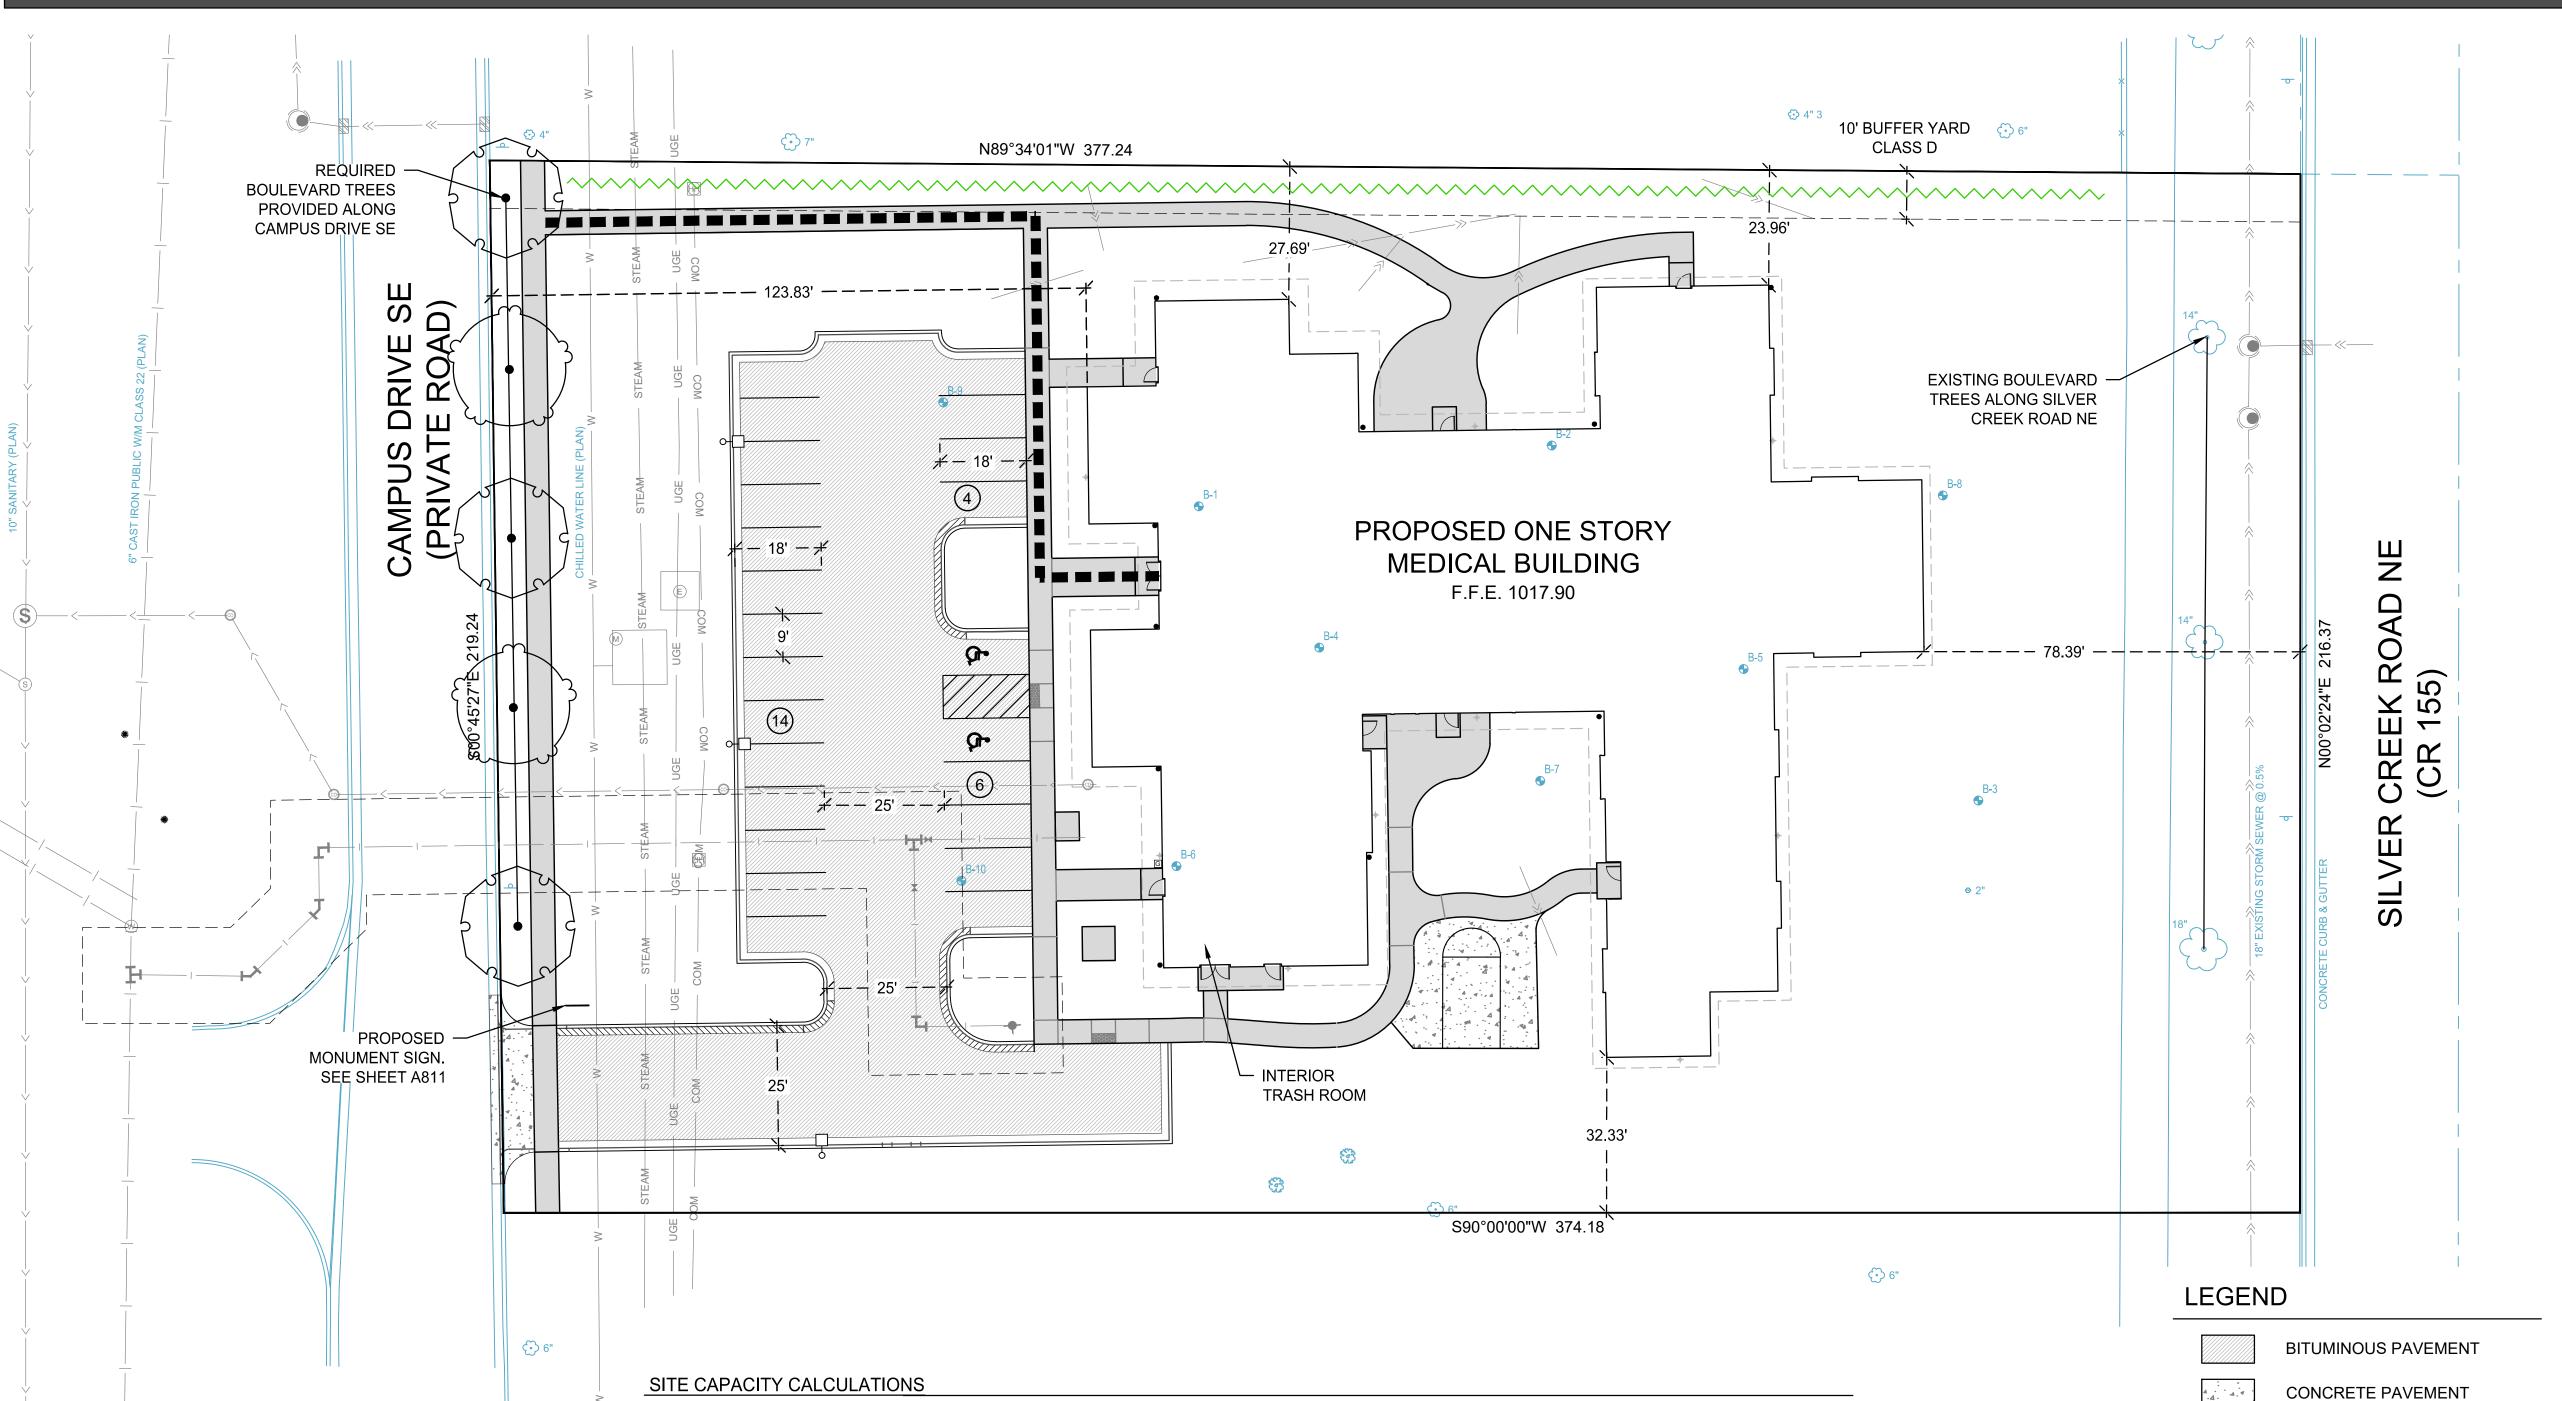

### SITE DEVELOPMENT PLAN NOTES

- REFER TO ARCHITECTURAL AND/OR STRUCTURAL PLANS FOR ACTUAL BUILDING DIMENSIONS AND STOOP LOCATIONS.
- 2. REFER TO SITE PHOTOMETRIC PLAN FOR SITE LIGHTING REQUIREMENTS.
- 3. SDP STORMWATER CALCULATIONS FOR OVERALL EXISTING AND PROPOSED DISCHARGE RATES ARE AS FOLLOWS:

<b>DESIGN STORM</b>	EXISTING (CFS)	PROPOSED (CFS)
2-YEAR	0.50	0.16
10-YEAR	2.38	0.40
25-YEAR	4.44	0.62
100-YEAR	8.90	1.23

# ADDRESS: 2121 CAMPUS DRIVE SE PARCEL PIN: 73-313-10-69-165

**EXISTING ZONING:** MRD MIXED REDEVELOPMENT PROPOSED ZONING: MRD MIXED REDEVELOPMENT PRIMARY USE: MEDICAL FACILITY

PROPOSED BASE SITE AREA: 81,824.51 SF 1.88 ACRES RESOURCE PROTECTION AREA: NET BUILDABLE AREA: 81,824.51 SF 1.88 ACRES

BUILDING SUMMARY: TOTAL FLOOR AREA 16,186.85 SF

**BUILDING HEIGHT:** MAXIMUM PERMITTED HEIGHT: NO LIMIT PROPOSED HEIGHT: 15'-6"

FLOOR AREA RATIO (FAR): RATIO SQUARE FEET PERMITTED FAR: 32,729.80 SF 0.20 16,186.85 SF PROPOSED FAR:

PARKING REQUIREMENTS: 5 STALLS PER PRINCIPAL MEDICAL PROFESSIONAL (3.4) 17 STALLS

TOTAL REQUIRED 17 STALLS TOTAL PROPOSED PARKING ON SITE 24 STALLS

9' X 18' STANDARD STALLS (22) VAN ACCESSIBLE ADA PARKING STALLS (2)

11,306.69 SF PAVED PARKING/DRIVE AISLES

SETBACKS	REQUIRED	PROPOSED
FRONT YARD	15'	123.83'
SIDE YARD (NORTH)	10'	23.96'
SIDE YARD (SOUTH)	10'	32.33'
REAR YARD	8'	78 39'

BUFFERYARDS SEE LS SERIES SHEETS FOR PROPOSED BUFFERYARD PLANTINGS.

CLASS D BUFFERYARD ON NORTH SIDE 377.24 LINEAR FEET OF BUFFERYARD LENGTH ON NORTH SIDE = 9 CANOPY PLANTINGS, 18 UNDERSTORY PLANTINGS, 30 SHRUBS WITHIN 10-FOOT BUFFERYARD

219.24 LINEAR FEET OF BOULEVARD LENGTH ALONG CAMPUS DRIVE SE / 35 FEET = 6 TREES, 5 TREES PROPOSED DUE TO OBSTRUCTIONS FROM DRIVEWAY AND UTILITIES.

216.37 LINEAR FEET OF BOULEVARD LENGTH ALONG SILVER CREEK ROAD NE / 35 FEET = 6 TREES, 3 EXISTING TREES IN BOULEVARD ARE TO REMAIN AND

COUNT TOWARD BOULEVARD TREE REQUIREMENTS


LANDSCAPE AREA: REQUIRED PROPOSED

SIGNAGE:

46,029.05 SF 1.06 ACRES 56%


TYPE B - 2' SETBACK FROM SIDEWALK




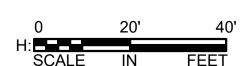

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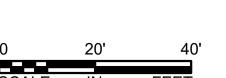
THE SOUTHWEST QUARTER OF SECTION 31, TOWNSHIP 107 NORTH, RANGE 13 WEST, 81,825 SQ. FT. MORE OR LESS.



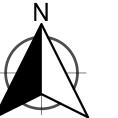

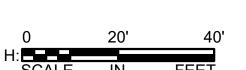THAT PART OF THE SOUTHEAST QUARTER OF OLMSTED COUNTY, MINNESOTA, CONTAINING







3701 40th Ave. NW Suite 100 Rochester, MN 55901 Tel: 507.218.3369

OLMSTED COUNTY OFFICES

151 SE 4th Street Rochester, mn 55904

	ON FULL SIZE S	HEETS
2	02-19-20	SECOND CITY REVIEW
1	01-24-20	50% CD PRICING SET
1	01-24-20	INITIAL CITY REVIEW
NO	DATE	ISSUED FOR
NO	DATE	REVISION

THIS SQUARE APPEARS 1/2"x1/2"

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PROJECT NAME:

CONCRETE FLATWORK

PARKING STALL COUNT

IDENTIFICATION

LEASE HOLD LINE

STORM SEWER

WATER MAIN

■ ■ ■ ADA ACCESSIBLE ROUTE

SANITARY SEWER

SOIL BORING LOCATION AND

PROPOSED UTILITY EASEMENT

10' BUFFERYARD - CLASS D

PROPOSED BOULEVARD TREE

PROPOSED RPU ELECTRIC EASEMENT

Southeast Regional Crisis Center (SERCC)

2121 Campus Drive SE Rochester, MN 55904


DRAWING TITLE:

SITE DEVELOPMENT PLAN

DESIGN BY: JMS DRAWN BY: PROJ. NO:

SCALE:

EXTERIOR LIGHTING: TYPE B

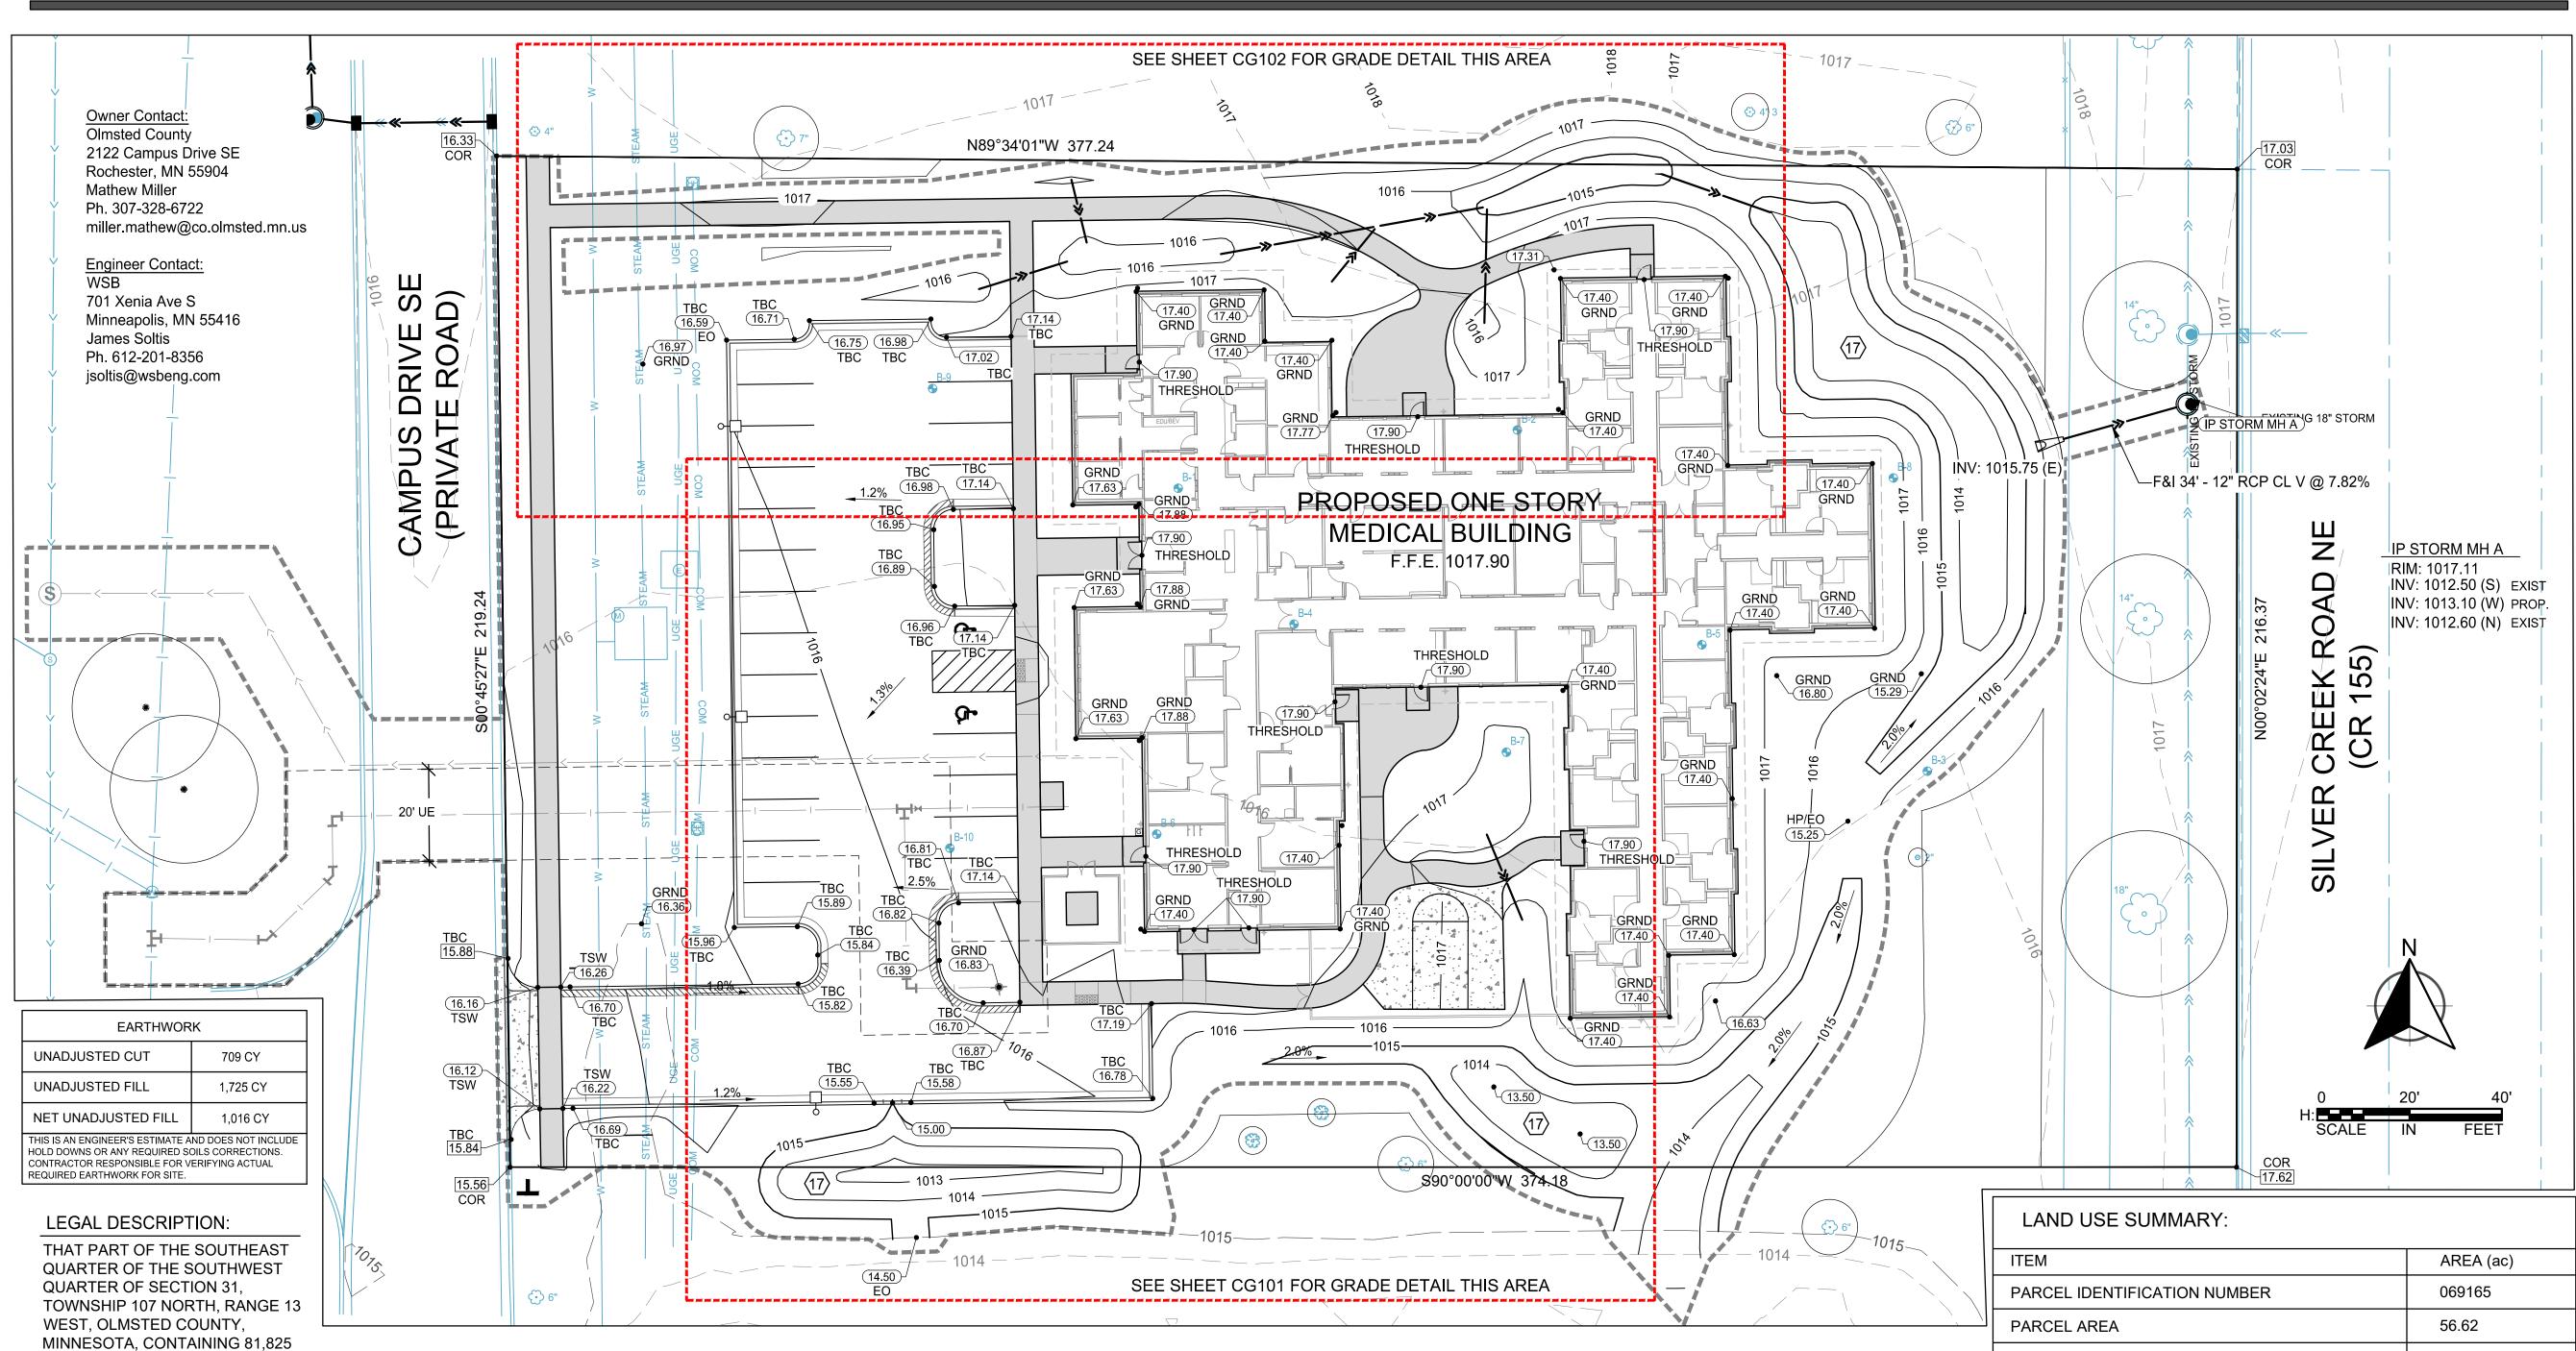

### **GRADING NOTES**

SQ. FT. MORE OR LESS.

- THE PROPOSED GRADES SHOWN ON THE GRADING PLAN ARE FINISHED GRADES.
- GRADING ACTIVITY WHICH BLOCKS TRAFFIC OF ANY STREET, ALLEY, OR DRIVE IS SUBJECT TO APPROVAL BY THE CITYAND COUNTY.
- CONTRACTOR SHALL STOP WORK IMMEDIATELY AND NOTIFY THE ENGINEER AND OWNER IF CONTAMINANTS ARE FOUND IN THE EXISTING SOILS.
- SIDEWALK CROSS-SLOPES SHALL NOT EXCEED 2.0% AND LONGITUDINAL SLOPES SHALL NOT EXCEED 5.0% UNLESS OTHERWISE NOTED.
- IN AREAS WHERE NEW FILL IS TO BE PLACED ON SLOPING GROUND, BENCHING THE SURFACE SHALL BE COMPLETED PRIOR TO PLACING THE FILL. BENCHING SHALL BE COMPLETED WHERE SLOPES ARE STEEPER THAN 4:1 (HORIZONTAL:VERTICAL).
- PROVIDE POSITIVE DRAINAGE AT ALL TIMES WITHIN THE CONSTRUCTION AREA. DO NOT ALLOW WATER TO POND IN EXCAVATION AREAS, AND MAINTAIN ALL EXISTING DRAINAGE PATTERNS.
- PERVIOUS FINISH GROUND SURFACES SHALL SLOPE AWAY FROM THE PROPOSED BUILDING FOUNDATIONS AT A MINIMUM OF 5% FOR THE FIRST 10 FEET. IMPERVIOUS SURFACES ADJACENT BUILDING FOUNDATIONS SHALL SLOPE AWAY FROM THE FOUNDATION AT A MINIMUM OF 2% FOR THE FIRST 10 FEET. (MEASURED PERPENDICULAR TO THE FOUNDATION) SLOPES ARE MEASURED FROM GRADE ADJACENT THE FOUNDATION, NOT FROM THE TOP OF FOUNDATION OR FLOOR ELEVATION. SEE ALSO MINNESOTA BUILDING CODE 1804.3.
- ALL EXTERIOR BUILDING WALLS AND FOUNDATION ADJACENT NON PAVED AREAS SHALL BE WATERPROOFED TO AN ELEVATION 0.5' ABOVE EXTERIOR PERVIOUS FINISH GRADE IN ACCORDANCE WITH ARCHITECTURAL PLANS AND SPECIFICATIONS.
- THE CONTRACTOR SHALL BE RESPONSIBLE TO COMPLY WITH ALL OSHA REGULATIONS IN THE EXECUTION OF WORK UNDER THIS CONTRACT.

- 10. THE CONTRACTOR SHALL APPLY FOR A CITY OF ROCHESTER GRADING PERMIT BEFORE STARTING WORK. THE INSPECTOR AND THE CITY OF ROCHESTER PUBLIC WORKS DEPARTMENT SHALL BE NOTIFIED BY THE CONTRACTOR 48 HOURS BEFORE START OF CONSTRUCTION. NO WORK MAY BEGIN UNTIL THE PERMIT HAS BEEN RECEIVED AND THE CONTRACTOR MUST COMPLY WITH THE TERMS OF THE PERMIT.
- ALL NON-PAVED AREAS SHALL RECEIVE A FOUR-INCH (4") LAYER OF TOPSOIL. SEE EROSION AND SEDIMENT CONTROL PLANS & SPECIFICATIONS FOR TEMPORARY AND PERMANENT STABILIZATION
- 12. ALL GRADES WITHIN THE LANDSCAPED AREA SHALL NOT EXCEED 3 HORIZONTAL TO 1 VERTICAL AND HAVE A MINIMUM GRADE OF 2%, UNLESS OTHERWISE NOTED. GRADED SWALES MUST HAVE A MINIMUM BOTTOM SLOPE OF 2.0%. SLOPES STEEPER THAN 4:1 ARE STABLE FROM LAND SLIDING AND SURFACE
- 14. ALL CONCRETE WASHOUT PRACTICES MUST MEET OR EXCEED THE MPCA STANDARDS.
- (E.G. PUMPED DISCHARGES, TRENCH/DITCH CUTS FOR DRAINAGE) SHALL DISCHARGE INTO A TEMPORARY OR PERMANENT SEDIMENT BASIN UNLESS INFEASIBLE. IF A SEDIMENT BASIN IS NOT AVAILABLE, THE CONTRACTOR SHALL TREAT ALL DISCHARGE WITH APPROPRIATE BMP's SO THAT ANY DISCHARGE DOES NOT ADVERSELY AFFECT THE SURFACE WATER OR DOWNSTREAM PROPERTIES.
- JUNE 19, 2019 FOR SUBSURFACE DATA, RECOMMENDATIONS AND BORING LOGS.
- DRAINAGE FEATURE SOILS SHALL BE AMENDED ACCORDING TO MPCA SOIL MIX A. INFILTRATION RATES SHALL BE VERIFIED WITH A DOUBLE RING INFILTROMETER TO BE BETWEEN 0.80 AND 8.3 IN/HR.

OTHERWISE NOTED. PROPOSED WATERMAIN AND APPURTENANCES ARE PUBLIC.

# LEGEND


LLOLIND	
1019	PROPOSED CONTOUR
~ 1013	EXISTING CONTOUR
10.00	PROPOSED SPOT ELEVATION
10.00	EXISTING SPOT ELEVATION
TBC	TOP BACK OF CURB
TSW	TOP OF SIDEWALK
GRND	EXTERIOR GROUND ELEVATION
COR	PROPERTY CORNER
EO	EMERGENCY OVERFLOW
HP	HIGH POINT
	CONCRETE FLATWORK
A - A . A .	CONCRETE PAVEMENT



3701 40th Ave. NW Suite 100 Rochester, MN 55901 Tel: 507.218.3369

# OLMSTED COUNTY OFFICES

151 SE 4th Street Rochester, mn 55904

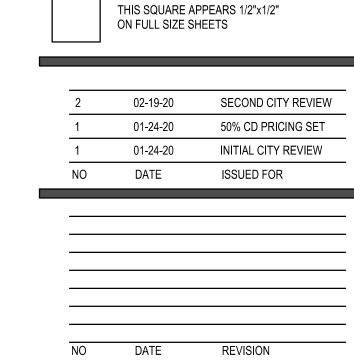

I HEREBY CERTIFY THAT THIS PLAN, SPECIFICATION, OR REPORT WAS PREPARED BY ME OR UNDER MY DIRECT SUPERVISION AND THAT I AM A DULY LICENSED PROFESSIONAL ENGINEER UNDER THE LAWS OF THE STATE OF MINNESOTA.



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PROJECT NAME:

1.69

56.62

23.06

33.56

23.89

32.73

9.98

(+) 0.831

GRADING/DISTURBANCE AREA

DEVELOPABLE AREA 1 (PARCEL)

INCLUDING APPROVED 2118 SITE)

INCLUDING APPROVED 2118 SITE)

PROPOSED NEW IMPERVIOUS AREA

PROPOSED MAXIMUM ALLOWABLE

assumption.

IMPERVIOUS AREA IN FULLY-DEVELOPED

which is part of what the site area table is used for.

CONDITIONS <sup>2</sup> (BMP DRAINAGE AREA)

PRE-DEVELOPMENT IMPERVIOUS AREA (PARCEL

PRE-DEVELOPMENT PERVIOUS AREA (PARCEL

POST-DEVELOPMENT IMPERVIOUS AREA (PARCEL)

<sup>1</sup>Reference City Ordinance 77a.03.Subd. 4. Note that item D is not applicable

to developable area used to calculate the SWMPAC (as per 77a.05.Subd. 3),

<sup>2</sup> Stormwater BMPs and conveyance systems are designed based on this

POST-DEVELOPMENT PERVIOUS AREA (PARCEL)

Southeast Regional Crisis Center (SERCC)

2121 Campus Drive SE Rochester, MN 55904

DRAWING TITLE: **GRADING &** DRAINAGE PLAN

DESIGN BY: JMS DRAWN BY: CHECKED BY PROJ. NO:

SCALE:

13. SEE SHEET CG102 FOR PIPE BEDDING AND ADDITIONAL STORM SEWER DATA.

15. ALL DISCHARGE OF TURBID OR SEDIMENT-LADEN WATERS RELATED TO DEWATERING OR BASIN DRAINING

16. REFER TO "GEOTECHNICAL REPORT FOR: OLMSTED COUNTY CRISIS CENTER", PREPARED BY WSB, DATED

ALL PROPOSED SANITARY AND STORM SEWER WITHIN THIS SITE IS PRIVATE UNLESS

### **UTILITY NOTES**

- 1. THE CONTRACTOR SHALL OBTAIN ALL NECESSARY PERMITS FROM THE CITY OF ROCHESTER PUBIC WORKS DEPARTMENT PRIOR TO THE START OF CONSTRUCTION.
- 2. INSTALL ALL WATER MAINS AND APPURTENANCES IN ACCORDANCE WITH LATEST CITY OF ROCHESTER STANDARD SPECIFICATIONS & DETAIL PLATES, AWWA AMERICAN WATERWORKS ASSOCIATION AND THE NATIONAL FIRE PREVENTION ASSOCIATION (NFPA) STANDARDS.
- 3. COORDINATE INSPECTION AND TESTING FOR ALL UNDERGROUND UTILITIES WITH THE APPROPRIATE AUTHORITIES PRIOR TO COVERING TRENCHES. COMPLY WITH ALL LOCAL REQUIREMENTS. CONDUCT ALL TESTS TO THE SATISFACTION OF THE LOCAL AUTHORITIES.
- 4. COORDINATES ARE TO END OF PIPE, CENTER OF APPURTENANCE, OR CENTER OF STRUCTURE UNLESS OTHERWISE NOTED.
- 5. ALL UTILITIES AND CONDUITS SHALL TERMINATE 5' OUTSIDE THE FACE OF THE BUILDING UNLESS OTHERWISE NOTED.
- 6. ALL EXISTING UTILITIES AND SERVICE LINES SHALL BE KEPT IN SERVICE AT ALL TIMES DURING CONSTRUCTION OF THIS PROJECT, UNLESS OTHERWISE AUTHORIZED BY OWNER.
- 7. REPORT ANY DISCREPANCIES TO THE ENGINEER. RECONNECT ALL SERVICES NOT MARKED FOR REMOVAL OR
- AS DIRECTED BY THE OWNER.
- 8. PROVIDE MECHANICAL JOINT RESTRAINT AS REQUIRED BY CITY OF ROCHESTER SPECIFICATION W200.302, C, 13.
- 9. IN THE EVENT OF A CONFLICT BETWEEN WATER LINES AND STORM OR SANITARY SEWER PIPING, ADJUST THE WATER LINE DOWNWARDS IN SUCH A MANNER SO THAT THE PIPE MANUFACTURER'S RECOMMENDATIONS ON PIPE DEFLECTION AND JOINT STRESS ARE NOT EXCEEDED.
- 10. CONDUCT A PRESSURE TEST ON ALL WATER MAIN AND FIRE PROTECTION LINES TO THE SATISFACTION OF THE LOCAL APPROVAL AUTHORITY AND THE OWNER'S INSURANCE CARRIER.
- 11. PROVIDE ALL WATER AND FIRE LINES WITH A MINIMUM DEPTH OF COVER OF 7.0 FEET.
- 12. HYDRANTS PLACED WHERE THE GROUNDWATER TABLE IS ABOVE THE DRAIN HOLE OUTLET SHALL HAVE THE DRAIN HOLE PLUGGED AND BE EQUIPPED WITH A TAG STATING THE NEED FOR PUMPING AFTER USE.
- 13. ALL POTABLE WATER PIPES, FITTINGS AND FIXTURES SHALL MEET THE 'REDUCTION OF LEAD IN DRINKING WATER ACT' WHICH ESTABLISHES A MAXIMUM LEAD CONTENT OF 0.25 PERCENT BY WEIGHTED AVERAGE OF THE WETTED SURFACES. HYDRANTS AND WATER DISTRIBUTION GATE VALVES 2 INCHES IN DIAMETER OR GREATER ARE EXEMPT.
- 14. THE CONTRACTOR SHALL ADJUST TO GRADE ALL WATER AND GAS VALVE BOXES AND MANHOLES THAT FALL

- WITHIN THE LIMITS OF THIS CONTRACT. THE CONTRACTOR SHALL KEEP ALL SAID WATER, GAS AND EXISTING SEWERS AND THEIR APPURTENANCES FREE OF DEBRIS AND OPERABLE AT ALL TIMES DURING CONSTRUCTION.
- 15. A #11 AWG TRACER WIRE SHALL BE INSTALLED ON ALL NON-METALLIC PIPES, THE WIRE SHALL BE TAPED TO THE PIPE EVERY 20 FEET, AND SHALL BE CONTINUOUS AND ACCESSIBLE ABOVEGROUND AT ALL VALVES AND BUILDING PISERS
- 16. SEE SPECIFICATIONS FOR WARNING TAPE REQUIREMENTS.
- 17. REFER TO MECHANICAL PLANS FOR CONTINUATION OF UTILITIES INTO THE BUILDING.
- 18. 10-FOOT HORIZONTAL SEPARATION REQUIRED BETWEEN SEWER LINES AND/OR STRUCTURES AND POTABLE WATER LINES.
- 18.a. WHERE THIS PROVISION CANNOT BE MET BETWEEN SEWER LINES AND POTABLE WATER LINES, SEWER PIPES SHALL BE PRESSURE RATED PVC (C900, SCH 40, SCH 80 OR SDR 26 PER ASTM D2241).
- 18.b. UNDER NO CIRCUMSTANCES SHALL POTABLE WATER LINES BE WITHIN 10' OF SEWER STRUCTURES UNDER THE JURISDICTION OF THE DEPARTMENT OF LABOR & INDUSTRY (DLI). SEWER STRUCTURES WITHIN 10' OF POTABLE WATER LINES THAT ARE NOT UNDER THE JURISDICTION OF DLI SHALL BE CONSTRUCTED TO ENSURE WATER TIGHTNESS MEETING MINNESOTA DEPARTMENT OF HEALTH STANDARDS.
- 19. MINIMUM 6-INCH VERTICAL SEPARATION REQUIRED AT ALL UTILITY CROSSINGS. POTABLE WATER LINES SHALL BE MINIMUM 18" ABOVE OR 18" BELOW SEWER LINES AT CROSSINGS. WHERE POTABLE WATER IS LOCATED BELOW OR LESS THAN 18" ABOVE SEWER LINES, SEWER PIPES SHALL BE PRESSURE RATED PVC (C900, SCH 4O, SCH 80 OR SDR 26 PER ASTM D2241).
- 20. CONTRACTOR SHALL IDENTIFY, FIELD VERIFY AND COORDINATE ALL EXISTING AND PROPOSED UTILITY CROSSINGS IN THE FIELD. REPORT CONFLICTS REQUIRING REDESIGN TO THE ENGINEER OF RECORD.
- 21. REFER TO ELECTRICAL AND MECHANICAL PLANS FOR CONNECTIONS AT BUILDING FOR GAS, POWER AND COMMUNICATIONS. CONTRACTOR TO COORDINATE SERVICES WITH LOCAL UTILITY PROVIDERS, ARCHITECTURAL PLANS AND SPECIFICATIONS AND BUILDING CONTRACTOR PRIOR TO INSTALLATION.
- 22. CONTRACTOR SHALL COORDINATE THE CONSTRUCTION ACTIVITIES WITH THE ANTICIPATED COUNTY ROAD 9 (COLLEGE VIEW RD E) AND COUNTY ROAD 155 (SILVER CREEK RD SE) PROJECTS.

### **LEGEND**

PROPOSED WATERMAIN AND SERVICE

PROPOSED SANITARY SEWER

PROPOSED STORM SEWER

SANITARY MANHOLE

STORM SEWER STRUCTURES

♦ HYDRANT

₩ WATER VALVE

© CLEANOUT

B-X
20' PUBLIC WATERMAIN
EASEMENT

---- GRADING/DISTURBANCE LIMITS

STA 0+00.00, 0.00'

F&I TIE TO INPLACE 6" DIP

F&I 6"x 6" TAPPING TEE AND VALVE

STA 0+25.00, 0.00' F&I 6" DIP - 45° BEND

W-3 STA 0+45.00, 0.00' F&I 6" DIP - 45° BEND

STA 0+57.86, 0.00' F&I 6" DIP - 90° BEND

STA 1+81.87, 0.00' F&I 6"x 6" DIP TEE W-6

STA 1+84.87, 0.00' RT F&I 6" GATE VALVE/BOX W-7 STA 2+18.23, 3.00' RT

F&I 6" DIP STUB & PLUG COORDINATE WITH ARCHITECTURAL PLANS AND BUILDING CONTRACTOR PRIOR TO CONSTRUCTION. (INV AT BLDG. = 1010.4 MIN) W-8

STA 0+14.29, 0.06' RT F&I 6" GATE VALVE/BOX W-9 STA 0+38.96, 0.00' F&I 6" DIP - 90° BEND W-10 STA 0+58.92, 3.00' RT F&I FIRE HYD'T ASSEMBLY BREAKOFF ELEV. 1017.03 (SEE 2/CU500)

SEE 5/CU500 FOR WATERMAIN PROIFILE

WATER SERVICE

CONSTRUCTION NOTES:

CU100 SCALE: NO SCALE

MH 1 SEE 1/CU500

F&I Type 3 (48") - R-1733

STA: 0+00.00, 0.00'

RIM: 1017.20

INV: 1006.40 (E)

CO 1 SEE 3/CU500

F&I 6" PVC Cleanout

per SDP 1-06 STA: 2+43.03, 0.00' RIM: 1017.5 INV: 1011.00 (E) INV: 1011.00 (W) CO 2 SEE 3/CU500 F&I 6" PVC Cleanout per SDP 1-06 STA: 1+67.13, 0.00' LT RIM: 1016.2

INV: 1008.07 (E)
INV: 1008.07 (W)
CO 3 SEE 3/CU500
F&I 6" PVC Cleanout
per SDP 1-06
STA: 0+85.93, 0.00'
RIM: 1016.0

STA: 0+85.93, 0.00 RIM: 1016.0 INV: 1007.26 (E) INV: 1007.26 (NW)

CO 4 SEE 3/CU500

F&I 6" PVC Cleanout per SDP 1-06

STA: 0+42.79, 0.00'

RIM: 1016.5

INV: 1006.83 (SE)


INV: 1006.83 (W)


SEWER PIPES SHALL BE PRESSURE RATED PVC (C900, SCH 4O, SCH 80 OR SDR 26 PER ASTM D2241).

SANITARY SEWER SERVICE

CONSTRUCTION NOTES:

CU100 SCALE: NO SCALE

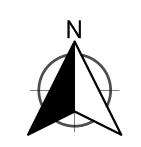

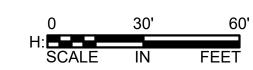



701 Washington Ave. N, Ste 200 | Minneapolis, MN 55401 | 612.338.2029



**WSB** 

3701 40th Ave. NW Suite 100 Rochester, MN 55901 Tel: 507.218.3369

IENT:

OLMSTED COUNTY OFFICES

151 SE 4th Street Rochester, mn 55904

> THIS SQUARE APPEARS 1/2"x1/2" ON FULL SIZE SHEETS

 2
 02-19-20
 SECOND CITY REVIEW

 1
 01-24-20
 50% CD PRICING SET

 1
 01-24-20
 INITIAL CITY REVIEW

 NO
 DATE
 ISSUED FOR

I HEREBY CERTIFY THAT THIS PLAN, SPECIFICATION, OR REPORT WAS PREPARED BY ME OR UNDER MY DIRECT SUPERVISION AND THAT I AM A DULY LICENSED PROFESSIONAL ENGINEER UNDER THE LAWS OF THE STATE OF MINNESOTA.



DATE: 02-19-2020 LIC. NO: 54823

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Southeast Regional Crisis Center (SERCC)

2121 Campus Drive SE Rochester, MN 55904

DRAWING TITLE:

UTILITY PLAN

DESIGN BY: JMS
DRAWN BY: PJM
CHECKED BY: JMT
PROJ. NO: 015264SCALE: AS SHO

CU100

**PERFORMANCE** DRIVEN DESIGN. LHBcorp.com

701 Washington Ave. N, Ste 200 | Minneapolis, MN 55401 | 612.338.2029



3701 40th Ave. NW Suite 100 Rochester, MN 55901 Tel: 507.218.3369

OLMSTED COUNTY OFFICES

151 SE 4th Street Rochester, mn 55904

	THIS SQUARE AI ON FULL SIZE SI	PPEARS 1/2"x1/2" HEETS
2	02-19-20	SECOND CITY REVIEW
1	01-24-20	50% CD PRICING SET
1	01-24-20	INITIAL CITY REVIEW
NO	DATE	ISSUED FOR

I HEREBY CERTIFY THAT THIS PLAN, SPECIFICATION, OR REPORT WAS PREPARED BY ME OR UNDER MY DIRECT SUPERVISION AND THAT I AM A DULY LICENSED LANDSCAPE ARCHITECT UNDER THE LAWS OF THE STATE OF MINNESOTA

EVA M. KELLY, PLA

DATE: 02-19-2020 LIC. NO: 51345

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PROJECT NAME:

Southeast Regional Crisis Center (SERCC)

2121 Campus Drive SE Rochester, MN 55904


DRAWING TITLE:

LANDSCAPE PLAN

DESIGN BY:	JMS	
DRAWN BY:	PJM	
CHECKED BY:	JMT	
PROJ. NO:	015264-000	LS100
SCALE:	AS SHOWN	



- PLANTINGS. SEE CIVIL PLANS
- (7) SITE LIGHTING, SEE ARCH PLANS

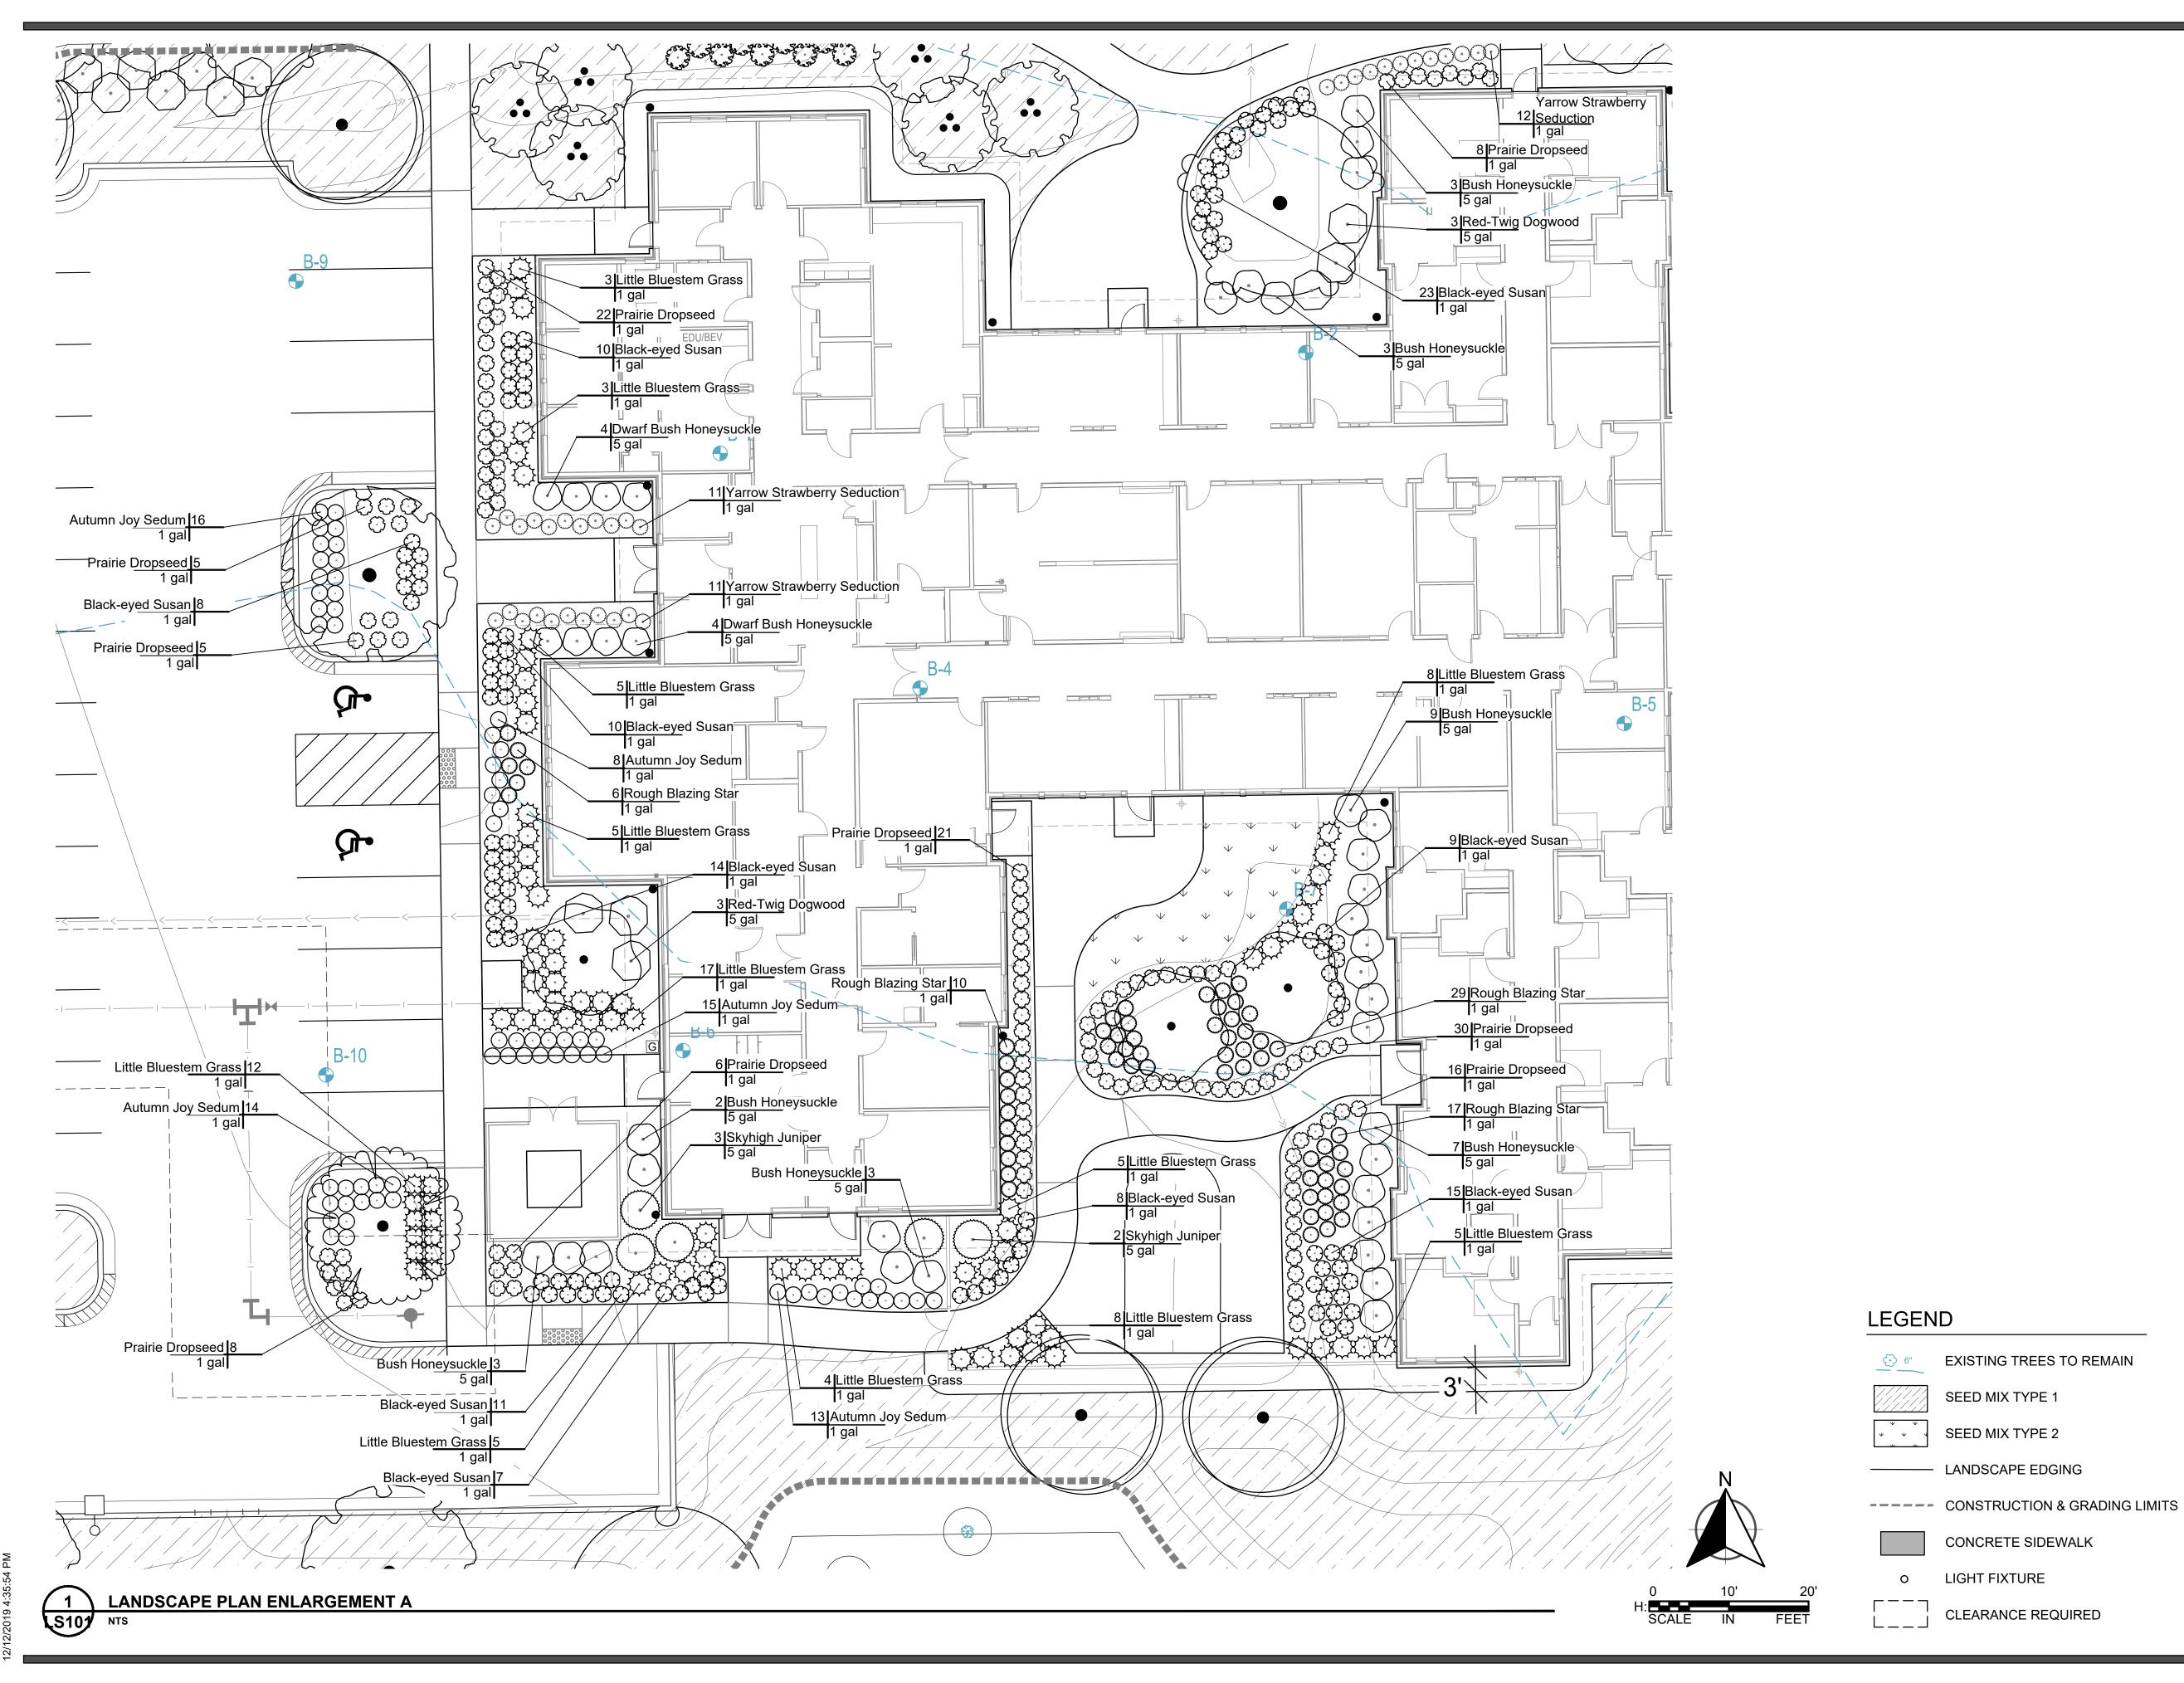



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#### WSE

3701 40th Ave. NW Suite 100 Rochester, MN 55901 Tel: 507.218.3369

CLIENT:

# OLMSTED COUNTY OFFICES

151 SE 4th Street Rochester, mn 55904

THIS SQUARE APPEARS 1/2"x1/2"
ON FULL SIZE SHEETS

2 02-19-20 SECOND CITY REVIEW
1 01-24-20 50% CD PRICING SET
1 01-24-20 INITIAL CITY REVIEW
NO DATE ISSUED FOR

O DATE REVISION

I HEREBY CERTIFY THAT THIS PLAN, SPECIFICATION, OR REPORT WAS PREPARED BY ME OR UNDER MY DIRECT SUPERVISION AND THAT I AM A DULY LICENSED LANDSCAPE ARCHITECT UNDER THE LAWS OF THE STATE OF MINNESOTA.

EVA KELLY

DATE: 02-19-2020 LIC. NO: 010896

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PROJECT NAME:

Southeast Regional Crisis Center (SERCC)

2121 Campus Drive SE Rochester, MN 55904

DRAWING TITLE:

LANDSCAPE PLAN ENLARGEMENT

DESIGN BY: JMS
DRAWN BY: PJM
CHECKED BY: JMT
PROJ. NO: 01526

SCALE:

M ATT 5264-000 S SHOWN **LS101** 

K:\u15264-000\cad\rian\u15264-000 L-PLNI -PLAN.awg 2/19/2020 11:15:25 AM BIM 360://180475 Rochester Crisis Center/180475 Rochester Crisis Center\_A2

# PLANT SCHEDULE

TREES	QTY	BOTANICAL / COMMON NAME	CONT
•	4	Acer rubrum / Red Maple	2.5" Cal B&B
	3	Betula nigra / River Birch	2.5" Cal B&B
	4	Celtis occidentalis / Common Hackberry	2.5" Cal B&B
$\{\cdot\}$	3	Gleditsia triacanthos inermis `Skycole` TM / Honeylocust	2.5" Cal B&B
	4	Gymnocladus dioica `Espresso` / Kentucky Coffeetree	2.5" Cal B&B
	5	Quercus bicolor / Swamp White Oak	2.5" Cal B&B
( · )	2	Quercus macrocarpa / Bur Oak	2.5" Cal B&B
MEDIUM TREES	<u>QTY</u>	BOTANICAL / COMMON NAME	CONT
$\left(\cdot\right)$	6	Malus x `Profusion` / Profusion Crabapple	1.5" CalB&B
SMALL TREES	<u>QTY</u>	BOTANICAL / COMMON NAME	CONT
	9	Amelanchier canadensis / Shadblow Serviceberry	5 gal
	4	Amelanchier x grandiflora `Autumn Brilliance` / AB Serviceberry	1.5" Cal B&B
(•)	8	Crataegus crus-galli / Thornless Hawthorn	1.5" Cal B&B
SHRUBS	QTY	BOTANICAL / COMMON NAME	SIZE
$\overline{}$	26	Cornus sericea `Alleman`s Compact` / Red-Twig Dogwood	5 gal
$\odot$	30	Diervilla lonicera / Bush Honeysuckle	5 gal
$\odot$	8	Diervilla Ionicera / Dwarf Bush Honeysuckle	5 gal
$\odot$	5	Juniperus scopulorum `Bailigh` / Skyhigh Juniper	5 gal
	22	Ribes aureum / Golden Currant	1 gal
$\bigcirc$	6	Symphoricarpos albus / Common Snowberry	5 gal
GRASSES / SEDGE	QTY	BOTANICAL / COMMON NAME	<u>SIZE</u>
<b>\(\frac{1}{2}\)</b>	80	Schizachyrium scoparium / Little Bluestem Grass	1 gal
$\bigcirc$	121	Sporobolus heterolepis / Prairie Dropseed	1 gal
PERENNIAL	QTY	BOTANICAL / COMMON NAME	SIZE
<u> </u>	34	Achillea millefolium `Strawberry Seduction` / Yarrow Strawberry Seduction	1 gal
0	62	Liatris aspera / Rough Blazing Star	1 gal
$\odot$	115	Rudbeckia Goldstrum / Black-eyed Susan	1 gal
$\odot$	66	Sedum x `Autumn Joy` / Autumn Joy Sedum	1 gal

#### SEED MIX TYPE 2 - DROUGHT TOLERANT TURF GRASS

Planting Area: Statewide

25-131	Low Maintenance Turf				
Common Name	Scientific Name	Rate (kg/ha)	Rate (lb/ac)	% of Mix (% by wt)	Seeds/ sq ft
Low Maintenance Kentucky bluegrass	Poa pratensis Low Maintenance	40.35	36.00	16.36%	1148.70
Sheep Fescue	Festuca ovina	28.02	25.00	11.37%	304.22
red fescue	Festuca rubra	71.73	64.00	29.09%	667.00
Chewing's Fescue	Festuca rubra ssp. commutata	49.32	44.00	20.00%	458.60
Hard fescue	Festuca trachyphylla	33.63	30.00	13.64%	389.10
Perennial Ryegrass	Lolium perenne	23.54	21.00	9.54%	104.60
	Totals:	246.59	220.00	100.00%	3072.22

SEED MIX TYPE 1 - NATIVE POLLINATOR



MNL Pollinator Mix Dry to Mesic Soils

% of Seeds/ PLS Bloom

8740 77th Street NE Otsego, MN 55362

Forb Species:

Mix approved by the Xerces Society for Pollinator habitat enhancement and restoration. For dry and well-drained to mesic soils. Height 2-3'

	Scientific Name	Common Name	Mix	Sq Ft	lbs/ac	Season
Grasses:	Bouteloua curtipendula	Side-Oats Grama	16.00	5.85	1.60	
	Bouteloua gracilis	Blue Grama	4.00	5.88	0.40	
	Bromus kalmii	Prairie Brome	3.00	0.88	0.30	
	Elymus trachycaulus	Slender Wheat Grass	2.00	0.51	0.20	
	Koeleria macrantha	Junegrass	0.50	3.21	0.05	
	Schizachyrium scoparium	Little Bluestem	17.00	9.37	1.70	
	Sporobolus heterolepis	Prairie Dropseed	1.50	0.88	0.15	
Sedges/Rushes:	Carex bicknellii	Bicknell's Sedge	1.00	0.62	0.10	
Forbs:	Achillea millefolium	Yarrow	0.20	1.29	0.02	Summer
	Agastache foeniculum	Fragrant Giant Hyssop	0.50	1.65	0.05	Summe
	Allium stellatum	Prairie Onion	0.60	0.24	0.06	Summe
	Amorpha canescens	Leadplant	3.00	1.76	0.30	Summe
	Anemone canadensis	Canada Anemone	1.00	0.29	0.10	Spring
	Aquilegia canadensis	Columbine	0.35	0.49	0.04	Spring
	Asclepias speciosa	Showy Milkweed	0.50	0.08	0.05	Summe
	Asclepias syriaca	Common Milkweed	1.75	0.26	0.18	Summe
	Asclepias tuberosa	Butterfly Milkweed	1.50	0.24	0.15	Summe
	Astragalus canadensis	Canada Milk Vetch	2.00	1.25	0.20	Summe
	Chamaecrista fasciculata	Partridge Pea	7.00	0.69	0.70	Fall
	Coreopsis palmata	Prairie Coreopsis	0.30	0.11	0.03	Summe
	Dalea candida	White Prairie Clover	5.00	3.49	0.50	Summe
	Dalea purpurea	Purple Prairie Clover	7.50	4.13	0.75	Summe
	Desmodium canadense	Canada Tick Trefoil	4.00	0.81	0.40	Summe
	Echinacea angustifolia	Narrow-leaved Coneflower	1.50	0.39	0.15	Summe
	Heliopsis helianthoides	Common Ox-Eye	4.00	0.93	0.40	Summe
	Helianthus pauciflorus	Stiff Sunflower	0.25	0.04	0.03	Fall
	Lespedeza capitata	Round-headed Bushclover	1.50	0.44	0.15	Summe
	Liatris aspera	Rough Blazing Star	0.50	0.29	0.05	Summe
	Liatris ligulistylis	Meadow Blazing Star	1.00	0.37	0.10	Summe
	Monarda fistulosa	Wild Bergamot	0.60	1.54	0.06	Summe
	Penstemon gracilis	Slender Beardtongue	0.15	3.31	0.02	Spring
	Penstemon grandiflorus	Showy Penstemon	0.75	0.39	0.02	Spring
	Phlox pilosa	Prairie Phlox	0.10	0.07	0.01	Spring
	Pycnanthemum virginianum	Mountain Mint	0.20	1.62	0.02	Summe
	Ratibida columnifera	Long-Headed Coneflower	1.25	1.93	0.02	Summe
	Rudbeckia hirta	Black Eyed Susan	1.80	6.08	0.13	Summe
		Gray Goldenrod	0.20	2.20	0.10	Fall
	Solidago nemoralis					
	Solidago speciosa Symphyotrichum ericoides	Showy Goldenrod Heath Aster	0.20 0.25	0.70 1.84	0.02 0.03	Fall Fall
	Symphyotrichum laeve	Smooth Blue Aster	1.00	2.02	0.03	Fall
	Symphyotrichum oolentangiense	Sky Blue Aster	1.50	4.41	0.15	Fall
	Tradescantia bracteata	Prairie Spiderwort	0.60	0.22	0.06	Spring
	Verbena stricta	Hoary Vervain	1.50	1.54	0.15	Summe
	Zizia aptera	Heart-leaf Golden Alexanders	0.25	0.11	0.03	Spring
	Zizia aurea	Golden Alexanders	0.70 100.00	0.28 74.69	0.07 10.00	Spring
Seeds/sq ft:	75.00		_			
Grass Species:	7					
Sedges/Rush Sp:	1					
Forb Species:	37					

Seed mixes are subject to change based on availability



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#### WSE

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	2		
1 01-24-20 50% CD PRICING SET 1 01-24-20 INITIAL CITY REVIEW	2		SECOND CITY REVIE
1 01-24-20 INITIAL CITY REVIEW	1	04.04.00	
		01-24-20	50% CD PRICING SET
NO DATE ISSUED FOR	1	01-24-20	INITIAL CITY REVIEW
	NO	DATE	ISSUED FOR

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Portion

DATE: 02-19-2020 LIC. NO: 010896

EVA KELLY

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PROJECT NAME:

Southeast Regional Crisis Center (SERCC)

2121 Campus Drive SE Rochester, MN 55904

DRAWING TITLE:

LANDSCAPE SCHEDULE

DESIGN BY:	JMS	
DRAWN BY:	PJM	
CHECKED BY:	JMT	
PROJ. NO:	015264-000	1 550
SCALE:	AS SHOWN	LUJU

1. IDENTIFY 1ST MAIN ROOT AND REMOVE ALL SOIL AND ASSOCIATED ROOT MASS ABOVE IT. "BOX CUT" THE ROOT 1. A PLANTING PERMIT IS REQUIRED TO PLANT ANY TREE BALL BY USING A SAW TO CUT 4 FLAT SIDES REMOVING IN A RIGHT OF WAY IN THE CITY OF ROCHESTER

OUTER 1" OF SOIL AND ROOTS. MEASURE THE DEPTH OF THE ROOT BALL AND DIG HOLE TO THIS DEPTH. 2. IF TREES ARE BROUGHT TO THE SITE EARLY ENSURE THAT POTS ARE STORED IN A SHADED AREA AND ADEQUATELY WATERED BEFORE PLANTING

POTTED TREE ROOT BALL PREPARATION AND PLANTING

NOT TO SCALE

NURSERY STOCK" (ANSI Z60)

ADD SOIL IF SINK HOLES DEVELOF

NON-COMPACTED LOAM SOILS

VISIBLE WHEN BACK FILLING IS COMPLETE

SETTLING AND BACKFILL

3. IDENTIFY 1ST MAIN ROOT. SET AT GRADE. DIG HOLE


ONLY DEEP ENOUGH TO ALLOW FOR UNDISTURBED SOIL

DIRECTLY BENEATH TREE ROOTS TO MINIMIZE CHANCE OF

5. ROOT FLARE AND TOP OF 1ST MAIN ROOT MUST BE

6. EACH TREE REQUIRES A MINIMUM 800 CUBIC FEET OF


DEPARTMENT OF PUBLIC WORKS CITY OF ROCHESTER, MINNESOTA TREE PLANTING DETAIL TYPE 2 PARKS & REC DIRI

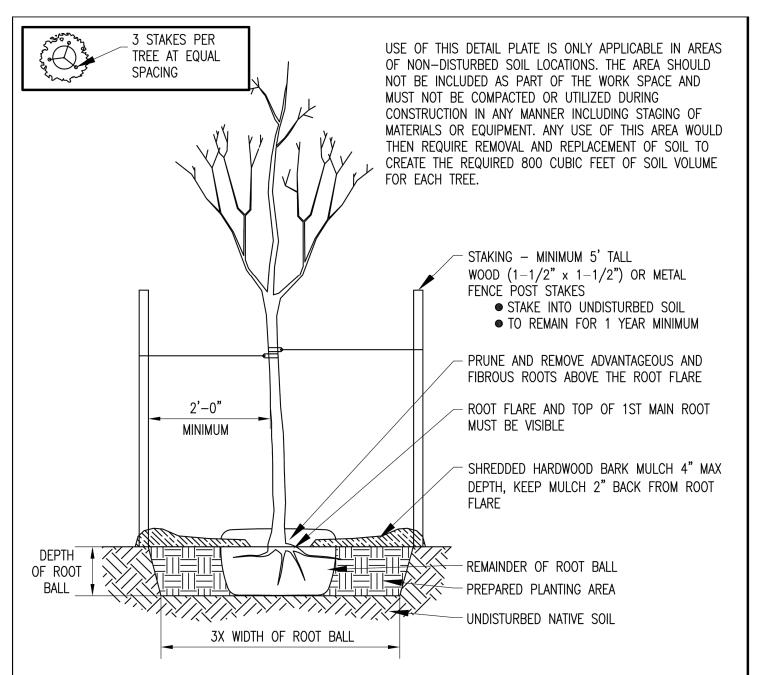

BALL AND BURLAP (B&B) ROOT BALL PREPARATION AND PLANTING

1. REMOVE TOP  $\frac{1}{3}$  OF PACKAGING TO FIND THE 1ST MAIN ROOT AND REMOVE ALL SOIL FROM ROOT BALL ABOVE IT DIG HOLE TO DEPTH OF REMAINING ROOT BALL DEPTH 1. A PLANTING PERMIT IS REQUIRED TO PLANT ANY TREE AND PLACE THE TREE IN THE HOLE. REMOVE ALL IN A RIGHT OF WAY IN THE CITY OF ROCHESTER REMAINING PACKAGING AND BACKFILL WITHOUT COMPACTING 2. ALL PLANTS MUST MEET THE "AMERICAN STANDARD FOR

2. IF TREES ARE BROUGHT TO THE SITE EARLY ENSURE THAT TREES ARE STORED IN A SHADED AREA AND ADEQUATELY WATERED BEFORE PLANTING

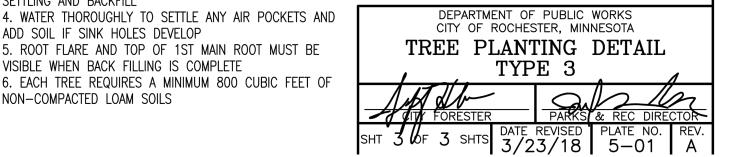

TREE PLANTING PER ROOT TYPE S501 NTS

2. ALL PLANTS MUST MEET THE "AMERICAN STANDARD FOR

3. IDENTIFY 1ST MAIN ROOT. SET AT GRADE. DIG HOLE

ONLY DEEP ENOUGH TO ALLOW FOR UNDISTURBED SOIL

DIRECTLY BENEATH TREE ROOTS TO MINIMIZE CHANCE OF

4. WATER THOROUGHLY TO SETTLE ANY AIR POCKETS AND

5. ROOT FLARE AND TOP OF 1ST MAIN ROOT MUST BE

6. EACH TREE REQUIRES A MINIMUM 800 CUBIC FEET OF


NURSERY STOCK" (ANSI Z60)

ADD SOIL IF SINK HOLES DEVELOP

NON-COMPACTED LOAM SOILS

VISIBLE WHEN BACK FILLING IS COMPLETE

SETTLING AND BACKFILL

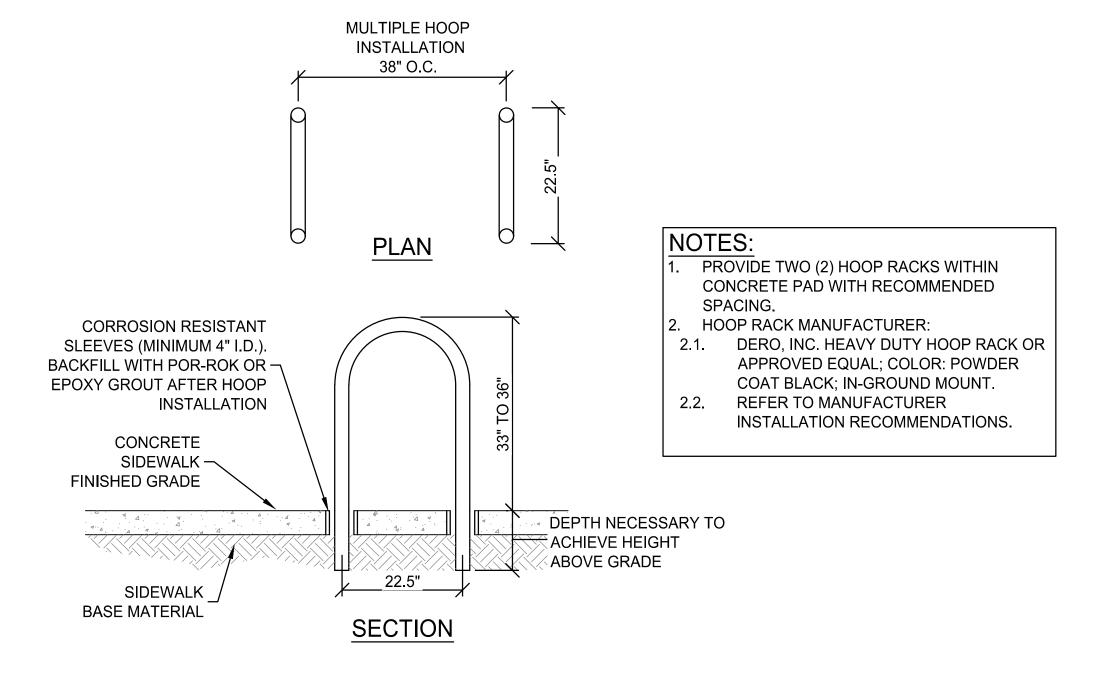

# LANDSCAPE NOTES

- 1. Prior to construction or demolition, Contractor is required to give 48 hour notice to Gopher State One for locating underground utility lines. This is a free service which will locate utility company lines (not privately or city owned). Prior to beginning work, Contractor shall have all utility locations marked on the project
- 2. Contractor shall verify that all permits are issued prior to beginning work including the Tree Planting Permit for work within R.O.W.
- 3. Contractor shall be responsible for any damage to existing items at Contractor's expense (incidental to this project).
- 4. Dimensions take precedence over scale, field verify items (FV) shall be field verified by the contractor. Discrepancies shall be immediately reported to the LA/E for clarification prior to any work being completed.

#### Existing Tree Protection and Tree Removals

- 5. Protect existing trees to remain per City of Rochester tree protection requirements including fencing and signage.
- 6. All items and trees not marked for removal or demolition shall remain proected and undisturbed during construction. Any damage to trees and items that are to remain shall be replaced at the Contractor's expense.
- 7. Contractor is responsible for removals of all plant materials (including trees, shrubs, groundcovers, etc) as directed by the removals plan and the LA/E, including grubbing, stump removal and disposal.
- 8. Contractor is required to attend a preconstruction meeting which will detail the requirements for protection/preservation of existing vegetation during and after the construction process.

#### Planting Bed and Soil Preparation

- 9. Onsite topsoil shall be re-spread to an average depth of 12 inches in all proposed planting and seeding areas. No topsoil shall be screened with less than a 3 inch screen. Topsoil shall be fine graded and raked to provide a smooth uniform surface. Refer to grading plans.
- 10. Organic matter shall be added to topsoil to achieve a minimum of 3.5% organic material by soil weight.
- 11. Remove any existing vegetation in planting beds, loosen the soil by rototilling if necessary. Rake soil smooth and remove all rocks and debris.
- 12. Contractor to refer to specifications section 32-91-13 for further instructions on soil preparation.

### Plant and Mulch Material

- 13. Plant material must meet specifications of the American Association of Nurseryman (AAN) for the number and grade.
- 14. Plant substitutions must be approved by the LA/E and owner.
- 15. All project plantings (such as trees, shrubs and perennials) must be free of neonicontinoid. Contractor must submit to LA/E (Landscape Architect/Engineer) a written chain of custody to verify neonictoninoid-free plantings.
- 16. Owner and LA/E have the right to reject any and all trees or plant material not meeting standards, details, B3 guidelines or specifications.
- 17. A 3' wide maintenance strip has been provided around the building perimeter in key locations, see Landscape Plan. Contractor to provide 4" depth double shredded hardwood mulch with poly edging. (Bid Alternate: 4" depth Small Trap Rock).

#### Planting Methods

- 1. Set out plants according to the plans and adjust spacing as needed for best fit.
- 2. Install plants per plan, details and specifications. Do not allow plants to dry out during installation. Water the planting bed thoroughly.
- 3. All soil, mulch and media that covers the trunk flare must be

#### removed.

- 4. The point of stem/root union shall be exposed at the original ground surface elevation.
- 5. All stem girdling roots (SGR) on trees shall be rejected or removed.
- 6. Trees shall not be planted deep in the planting hole to stabilize
- 7. Mulch shall not be placed against the tree trunk deeper than 1 in deep; the tree stem/root union should be planted 1 to 3 inches higher than surrounding ground plane elevation.
- 8. Crowns should not be pruned at planting to balance root and crown volumes.
- 9. Broken branches should be pruned and removed to develop a single central leader. Codominant branches that exceed half of tree trunk diameter at branch/trunk attachment point should be removed.
- 10. Trees in containers that are rootbound shall be box cut.
- 11. For balled and burlapped planting material:
  - a. The roots of all balled and burlapped stock shall fill the soil ball, be free of kinks, circling and girdling, and the uppermost roots shall not be more than four inches below the top of the soil ball. Transport roots shall be symmetrical around the trunk / stem of the plants. Soil balls must be centered or no more than 10% off center.
  - b. When moving plants, lift from beneath the root ball, do not lift by the trunk and do not break or loosen the rootball.
  - c. Backfill planting pit with original soil halfway to the top of the rootball. Break up clods of soil. If soils are poor (i.e. heavy clays, sand, or compacted), backfill can be a mixture of 1/3 soil amendment mixed with 2/3 original soil. Do no use peat as part of backfill in clay soils. Remove all rocks and debris from backfill and then water plant and backfilled area to settle plants and fill voids.
- d. Metal baskets and burlap shall be removed from B&B root balls to 12" below soil level. Continue backfilling remaining planting pit with original soil.

#### Watering, Care and Irrigation

- 12. Newly planted trees should be watered at a rate of 1.5 gallons per caliper inch per 3 calendar days from May through September, at the following intervals. Watering bags are
  - a. Year 1: At least every three days
  - b. Year 2: At least weekly
  - c. Year 3: At least every two weeks
- 13. Trees shall be staked, wrapped or otherwise secured upright and prevented from disease and damage. The contractor is responsible for insuring that all plantings are installed plumb and remain plumb prior to final acceptance and throughout the warranty period. If staking is installed all components shall be removed by the contractor at the end of the warranty period. Methods shall be discussed and approved with LA/E if outside specifications.
- 14. Irrigation is not provided as part of this project. No potable water is allowed to be used for irrigation after 5 years from
- 15. Water planting beds thoroughly after planting so that the water saturates the mulch layer. Thoroughly water the planting bed 2 to 3 times the first week of planting and 1-2 times per week until the warranty period is complete or as instructed by LA/E at time of final acceptance.

1. Refer to MnDOT seeding manual and specifications.



701 Washington Ave. N, Ste 200 | Minneapolis, MN 55401 | 612.338.2029



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# **OLMSTED COUNTY OFFICES**

151 SE 4th Street Rochester, mn 55904

THIS SQUARE APPEARS 1/2" ON FULL SIZE SHEETS
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02-19-20

1	01-24-20	50% CD PRICING SET
1	01-24-20	INITIAL CITY REVIEW
NO	DATE	ISSUED FOR

SECOND CITY REVIEW

I HEREBY CERTIFY THAT THIS PLAN, SPECIFICATION, OR REPORT WAS PREPARED BY ME OR UNDER MY DIRECT SUPERVISION AND THAT I AM A DULY LICENSED LANDSCAPE ARCHITECT UNDER THE

LAWS OF THE STATE OF MINNESOTA.

**EVA KELLY** 

DATE: 02-19-2020 LIC. NO: 010896

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Southeast Regional Crisis Center (SERCC)

2121 Campus Drive SE Rochester, MN 55904

DRAWING TITLE:

LANDSCAPE **DETAILS & NOTES** 

DESIGN BY: DRAWN BY: CHECKED BY PROJ. NO: SCALE:



**BIKE RACK**